SOMERSET TENNIS COMPLEX RENOVATION

ST MARY'S COLLEGE OF MARYLAND COLLEGE DRIVE ST. MARY'S CITY, MD 20686

DRAWING NUMBER	DRAWING DESCRIPTION
CIVIL	
G001	COVER SHEET
G002	GENERAL NOTES AND LEGENDS SHEET
C001	EXISTING CONDITIONS PLAN
C002	DEMOLITION AND EROSION PLAN
C101	LAYOUT AND MATERIALS PLAN
C102	GRADING AND DRAINAGE PLAN
C501	DETAIL PLAN
C502	DETAIL PLAN
C503	DETAIL PLAN
C504	DETAIL PLAN
C505	DETAIL PLAN

PREPARED FOR:

ST. MARY'S COLLEGE OF MARYLAND 18952 E. FISHER ROAD ST. MARY'S CITY, MD 20686

ENGINEER:

GALE ASSOCIATES INC. 217 N. WESTMONTE DR | STE 3033 | ALTAMONTE SPRINGS, FL 32714





GALE DRAWING SCALE COVER SHEET

G001

- 1. DEMOLITION TO COMPLY WITH GOVERNING EPA NOTIFICATION REGULATIONS BEFORE STARTING SELECTIVE DEMOLITION. COMPLY WITH HAULING AND DISPOSAL REGULATIONS OF AUTHORITIES HAVING JURISDICTION.
- 2. THE OWNER MAY OCCUPY PORTIONS OF THE BUILDING IMMEDIATELY ADJACENT TO SELECTIVE DEMOLITION AREAS. CONDUCT SELECTIVE DEMOLITION SO THAT OWNERS'S OPERATIONS WILL NOT BE DISRUPTED. PROVIDE NOT LESS THAN 72 HOURS NOTICE TO OWNER OF ACTIVITIES (IF ANY) THAT MAY AFFECT THEIR OPERATIONS.
- SURVEY THE CONDITION OF THE SITE TO DETERMINE WHETHER REMOVING ANY ELEMENT MIGHT RESULT IN UNDESIRABLE DAMAGE OF ANY PORTION OF ADJACENT FACILITIES DURING SELECTIVE DEMOLITION.
- 4. MAINTAIN EXISTING UTILITIES INDICATED TO REMAIN IN SERVICE AND PROTECT THEM AGAINST DAMAGE DURING SELECTIVE DEMOLITION OPERATIONS.
- 5. CONDUCT DEMOLITION OPERATIONS AND REMOVE DEBRIS TO ENSURE MINIMUM INTERFERENCE WITH ROADS, PARKING LOTS, STREETS, WALKS, AND OTHER ADJACENT OCCUPIED AND USED FACILITIES.
- 6. CONDUCT DEMOLITION OPERATIONS TO PREVENT INJURY TO PEOPLE AND DAMAGE TO ADJACENT BUILDINGS FACILITIES, AND SITE IMPROVEMENTS TO REMAIN. ENSURE SAFE PASSAGE OF PEOPLE AROUND SELECTIVE DEMOLITION AREA.
- 7. USE WATER MIST AND OTHER SUITABLE METHODS TO LIMIT THE SPREAD OF DUST AND DIRT. COMPLY WITH GOVERNING ENVIRONMENTAL PROTECTION REGULATIONS.
- 8. REMOVE AND TRANSPORT DEBRIS IN A MANNER THAT WILL PREVENT SPILLAGE ON ADJACENT SURFACES AND AREAS.
- 9. CLEAN ADJACENT STRUCTURES AND IMPROVEMENTS OF DUST, DIRT, AND DEBRIS CAUSED BY SELECTIVE DEMOLITION OPERATIONS. RETURN ADJACENT AREAS TO CONDITION EXISTING BEFORE START OF SELECTIVE DEMOLITION.
- 10. DEMOLISH AND REMOVE EXISTING CONSTRUCTION ONLY TO THE EXTENT REQUIRED BY NEW CONSTRUCTION AND AS INDICATED. CONTRACTOR TO BE RESPONSIBLE FOR ANY CUTTING AND PATCHING THAT IS REQUIRED.
- 11. PROMPTLY DISPOSE OF DEMOLISHED MATERIALS. DO NOT ALLOW DEMOLISHED MATERIALS TO ACCUMULATE ON-SITE.
- 12. BURNING MATERIALS ON SITE IS PROHIBITED.
- 13. TRANSPORT DEMOLISHED MATERIALS OFF OWNER'S PROPERTY AND LEGALLY DISPOSE OF THEM, IF NOT DESIGNATED TO BE SALVAGED BY THE OWNER OR REUSED.
- 14. IN AREAS WHERE BITUMINOUS CONCRETE IS TO BE REMOVED, THE EDGE OF ANY BITUMINOUS CONCRETE TO REMAIN MUST BE A CLEAN SAW-CUT EDGE.
- 15. THE CONTRACTOR SHALL STOCKPILE EXISTING LOAM TO BE REUSED IN PROPOSED LOAM AND SEED AREAS.

EROSION CONTROL NOTES

- 1. THE CONTRACTOR SHALL FILE A NOTICE OF INTENT SHOWING COMPLIANCE WITH THE NPDES CONSTRUCTION GENERAL PERMIT AS REQUIRED BY THE EPA AT LEAST 14 DAYS PRIOR TO GROUNDBREAKING. NPDES PERMIT AND PLANS SHALL BE KEPT ON SITE FOR REVIEW AT ALL TIMES FOR THE DURATION OF CONSTRUCTION.
- 2. ALL EROSION AND SEDIMENTATION CONTROL MEASURES SHALL BE CONSTRUCTED IN ACCORDANCE WITH STATE REGULATIONS AND ALL MUNICIPAL REGULATIONS AND PERMIT CONDITIONS.
- 3. EROSION AND SEDIMENTATION CONTROL MEASURES SHALL BE IN PLACE PRIOR TO THE COMMENCEMENT OF CONSTRUCTION AND SHALL BE MAINTAINED THROUGHOUT CONSTRUCTION.
- 4. STOCKPILES SHALL BE SURROUNDED ON THEIR PERIMETERS WITH STAKED SILTATION FENCES TO PREVENT AND/OR CONTROL SILTATION AND EROSION. OTHERWISE SPOIL MATERIAL SHALL BE IMMEDIATELY REMOVED FROM THE SITE AND DISPOSED OF LEGALLY AND IN CONFORMANCE TO ALL MUNICIPAL REGULATIONS. NO STOCKPILING SHALL OCCUR WITHIN THE 100-FOOT WETLAND BUFFER.
- 5. ALL EROSION CONTROL MEASURES SHALL BE ROUTINELY INSPECTED, CLEANED AND REPAIRED OR REPLACED AS NECESSARY THROUGHOUT ALL PHASES OF CONSTRUCTION. IN ADDITION, INSPECTION SHALL TAKE PLACE AFTER EACH RAINFALL EVENT AND BEFORE FORECASTED RAIN.
- 6. ALL SEDIMENTS MUST BE REMOVED PRIOR TO REACHING THE EXISTING DRAINAGE SYSTEMS AND/OR ANY ENVIRONMENTAL RESOURCE AREAS.
- 7. THE CONTRACTOR SHALL KEEP ON SITE AT ALL TIMES EXTRA SILTATION FENCING FOR INSTALLATION AT THE DIRECTION OF THE ENGINEER OR THE OWNER TO MITIGATE ANY EMERGENCY CONDITION.
- 8. THE AREA OR AREAS OF ENTRANCE AND EXIT TO AND FROM THE SITE SHALL BE MAINTAINED IN A CONDITION WHICH WILL PREVENT TRACKING OR FLOWING OF SEDIMENT. ALL SEDIMENT SPILLED, DROPPED, WASHED OR TRACKED OUTSIDE OF CONSTRUCTION AREA MUST BE REMOVED IMMEDIATELY.
- 9. SEDIMENT AND EROSION CONTROL DEVICES MAY BE ADDED OR REDUCED IN THE FIELD AS DIRECTED BY THE OWNER/ENGINEER.
- 10. THE CONTRACTOR IS RESPONSIBLE FOR REESTABLISHING ANY SEDIMENT AND EROSION CONTROL DEVICES WHICH THEY DISTURB. THE CONTRACTOR SHALL NOTIFY THE OWNER/ENGINEER OF ANY DEFICIENCIES IN THE ESTABLISHED SEDIMENT AND EROSION CONTROL MEASURES WHICH MAY LEAD TO UNAUTHORIZED DISCHARGE OR STORM WATER POLLUTION, SEDIMENTATION OR OTHER POLLUTANTS. UNAUTHORIZED POLLUTANTS INCLUDE, BUT ARE NOT LIMITED TO, EXCESS CONCRETE DUMPING OR CONCRETE RESIDUE, POINTS, SOLVENTS, GREASES, FUEL AND LUBE OIL, PESTICIDES, AND SOLID WASTE MATERIALS.

GRADING NOTES

- 1. ALL GRADING SHALL MEET THE REQUIREMENTS OF THE AMERICANS WITH DISABILITIES ACT (ADA) AND LOCAL BUILDING AND ACCESSIBILITY CODES. IN GENERAL, GRADING OF SIDEWALKS SHALL NOT EXCEED 2.0% CROSS SLOPE AND 5.0% RUNNING SLOPE, GRADING OF ADA PARKING STALLS AND LOADING ZONES SHALL NOT EXCEED 2.0% IN ANY DIRECTION AND GRADING OF PLAZA AND GATHERING AREAS SHALL NOT EXCEED 2.0% IN ANY DIRECTION. GRADING ON SIDEWALK CURB RAMPS AND OTHER ACCESSIBLE RAMPS SHALL NOT EXCEED 8.0%. ALL AREAS SHALL PROVIDE POSITIVE DRAINAGE AS TO NOT POOL WATER, MINIMUM SLOPES SHALL BE 1.0% UNLESS OTHERWISE NOTED.
- 2. ALL PROPOSED CONTOURS ARE APPROXIMATE. PROPOSED SPOT ELEVATIONS AND DESIGNED GRADIENT ARE TO BE USED IN THE EVENT OF ANY DISCREPANCIES.
- 3. GRADING SHALL BE PERFORMED TO ALLOW WATER TO FLOW AWAY FROM BUILDING STRUCTURES, AND TO NOT ALLOW PUDDLING OF WATER ANYWHERE ON SITE.
- 4. MINOR ADJUSTMENTS TO FINISH GRADE TO ACCOMPLISH DRAINAGE FLOW ARE ACCEPTABLE, IF NECESSARY, UPON PRIOR APPROVAL OF ENGINEER.
- 5. NEW PAVEMENT SHALL BE FLUSH AT ANY JUNCTURE WITH EXISTING PAVEMENT.
- 6. ALL EXCAVATIONS SHOULD BE STABILIZED BY CUTTING BACK SIDE SLOPES OR USING SHORING AND BRACING AS REQUIRED. ALL EXCAVATION AND SHORING SHALL BE DONE IN ACCORDANCE WITH OSHA STANDARDS AND MGL CH. 149 SECT. 129A.
- 7. ANY DEWATERING SHALL BE THE RESPONSIBILITY OF THE CONTRACTOR. DISCHARGE OF SILTY OR OTHERWISE "DIRTY" WATER INTO DRAINAGE SYSTEM OR ANY BODY OF WATER, WETLAND OR RESOURCE AREA SHALL NOT BE PERMITTED.

GENERAL NOTES

- 1. THE CONTRACTOR SHALL BE RESPONSIBLE FOR ESTABLISHING AND MAINTAINING ALL CONTROL POINTS AND BENCH MARKS NECESSARY FOR THE WORK. ALL EXISTING CONTROL POINTS AND BENCHMARKS HAVE BEEN PROVIDED ON THE EXISTING CONDITIONS PLANS. ANY ADDITIONAL CONTROL POINTS SHALL BE ESTABLISHED AND MAINTAINED BY THE CONTRACTOR.
- ALL CONSTRUCTION SHALL BE IN ACCORDANCE WITH THESE PLANS, AND MUNICIPAL STANDARDS. THE CONTRACTOR IS RESPONSIBLE FOR OBTAINING A COPY OF THE MUNICIPAL STANDARDS AND REGULATIONS FOR USE ON THIS PROJECT.
- 3. BARRICADING, TRAFFIC CONTROL, AND PROJECT SIGNS SHALL CONFORM TO ALL STATE AND LOCAL REGULATIONS. AREA ADJACENT TO THE PROJECT SITE WILL BE IN USE DURING CONSTRUCTION AT VARIOUS TIMES. THE CONTRACTOR WILL PROVIDE ADEQUATE CONSTRUCTION FENCING DURING EACH PHASE OF THE PROJECT TO FULLY SECURE THE PROPOSED SITE SUBJECT TO OWNER APPROVAL. THE FENCING MAY NEED ADJUSTMENT AT VARIOUS TIMES WITHOUT CONTRACT MODIFICATION.
- 4. THE GENERAL CONTRACTOR SHALL VERIFY THE SUITABILITY OF ALL EXISTING AND PROPOSED SITE CONDITIONS INCLUDING GRADES AND DIMENSIONS BEFORE COMMENCEMENT OF CONSTRUCTION. THE ENGINEER SHALL BE NOTIFIED IMMEDIATELY OF ANY DISCREPANCIES.
- 5. THE CONTRACTOR IS RESPONSIBLE FOR OBTAINING AND PAYING FOR ALL PERMITS AND/OR CONNECTION FEES REQUIRED. PLEASE NOTE BUILDING, PLUMBING, AND ELECTRICAL PERMIT FEES WILL BE WAIVED BY THE CITY OF SPRINGFIELD, CONTRACTOR TO REQUEST WAIVER FROM THE CITY PROJECT MANAGER.
- 6. GENERAL CONTRACTOR SHALL COORDINATE WITH OTHER TRADES AS APPLICABLE INCLUDING BUT NOT LIMITED TO ELECTRICAL, LIGHTING, AND GAS. THE CONTRACTOR ACKNOWLEDGES THAT ANOTHER CONTRACTOR WILL BE UNDER A SEPARATE CONTRACT. THE CONTRACTOR WILL COORDINATE HIS EFFORTS IN GOOD FAITH, AND WORK IN HARMONY WITH THE OTHER CONTRACTOR. NO EXTRA WILL BE AWARDED DUE TO CONFLICTS BETWEEN CONTRACTORS.
- 7. SUBSTITUTIONS AND APPROVAL OF "OR-EQUAL" PRODUCTS IN PLACE OF THOSE SPECIFIED WILL NOT BE ALLOWED WITHOUT WRITTEN AUTHORIZATION FROM THE OWNER OR ENGINEER.

GENERAL UTILITY NOTES

- 1. THE CONTRACTOR IS SPECIFICALLY CAUTIONED THAT THE LOCATION AND/OR ELEVATION OF EXISTING UTILITIES AND STRUCTURES AS SHOWN ON THESE PLANS IS BASED ON RECORD PLANS AND WHERE POSSIBLE, MEASUREMENTS TAKEN IN THE FIELD. THIS INFORMATION IS NOT TO BE RELIED ON AS BEING EXACT OR COMPLETE. THE LOCATION OF ALL UNDERGROUND UTILITIES AND STRUCTURES SHALL BE VERIFIED IN THE FIELD BY THE CONTRACTOR PRIOR TO THE START OF CONSTRUCTION.
- THE CONTRACTOR MUST CONTACT THE APPROPRIATE UTILITY COMPANY, ANY GOVERNING PERMITTING AUTHORITY, AND "DIGSAFE" AT LEAST 72 HOURS PRIOR TO ANY EXCAVATION WORK TO REQUEST EXACT FIELD LOCATION OF UTILITIES.
- 3. THE ENGINEER SHALL BE NOTIFIED IN WRITING OF ANY UTILITIES INTERFERING WITH THE PROPOSED CONSTRUCTION. IT SHALL BE THE RESPONSIBILITY OF THE CONTRACTOR TO RELOCATE EXISTING UTILITIES WHICH CONFLICT WITH THE PROPOSED IMPROVEMENTS SHOWN ON THE PLAN.
- 4. TRENCH EXCAVATIONS SHALL BE IN ACCORDANCE WITH ALL PROVISIONS OF OSHA PART 1926, SUBPART P
 -'EXCAVATIONS, TRENCHES AND SHORING OF THE OCCUPATIONAL SAFETY AND HEALTH'S STANDARDS AND
 NECESSARY TRENCH SAFETY PLANS TO THE ENGINEER AND MUNICIPAL FOR REVIEW PRIOR TO COMMENCING
 CONSTRUCTION.
- 5. ALL DRAIN, WATER AND SANITARY SEWER PIPES INSTALLED WITHIN 10 FEET OF THE BUILDING (BY OTHERS) MUST BE PERMITTED AND INSTALLED BY A MASSACHUSETTS LICENSED PLUMBER.
- 6. CONTRACTOR SHALL VERIFY ALL EXISTING INVERTS AND RIM ELEVATIONS PRIOR TO CONSTRUCTION.
- 7. THE CONTRACTOR SHALL ADJUST ALL UTILITY CASTINGS TO BE FLUSH WITH PROPOSED GRADE UNLESS OTHERWISE INDICATED ON PLAN.
- 8. THE CONTRACTOR SHALL FIELD COORDINATE WITH THE ELECTRICAL ENGINEER TO DETERMINE EXACT POINT OF SERVICE CONNECTION. REFER TO THE SITE ELECTRICAL DRAWINGS FOR UTILITY SERVICE ENTRANCE LOCATIONS, SIZES, AND CIRCUITING.
- 9. LIFTING HOLES ON CONCRETE STRUCTURES SHALL BE FILLED WITH MORTAR.

LANDSCAPING NOTES

- 1. PLANTS SHALL BE HEALTHY, VIGOROUS MATERIAL, FREE OF PESTS AND DISEASE.
- 2. PLANTS SHALL BE CONTAINER GROWN OR BALLED AND BURLAPPED.
- 3. TREES SHALL BE STRAIGHT-TRUNKED AND FULL-HEADED AND MEET ALL REQUIREMENTS SPECIFIED.
- 4. PLANTS ARE SUBJECT TO THE APPROVAL OF THE OWNER'S REPRESENTATIVE BEFORE, DURING, AND AFTER INSTALLATION.
- 5. TREES SHALL BE GUYED OR STAKED AS SHOWN IN THE DETAILS.
- 6. PLANTING AREAS SHALL BE COMPLETELY MULCHED AS SPECIFIED.
- 7. PRIOR TO CONSTRUCTION, THE CONTRACTOR SHALL BE RESPONSIBLE FOR LOCATING ALL UNDERGROUND UTILITIES AND SHALL AVOID DAMAGE TO ALL UTILITIES DURING THE COURSE OF THE WORK. THE CONTRACTOR IS RESPONSIBLE FOR REPAIRING ANY AND ALL DAMAGE TO UTILITIES, STRUCTURES, SITE APPURTENANCES, ETC. WHICH OCCURS AS A RESULT OF THE LANDSCAPE CONSTRUCTION.
- 8. THE CONTRACTOR IS RESPONSIBLE FOR FULLY MAINTAINING ALL PLANTING (INCLUDING BUT NOT LIMITED TO: WATERING, SPRAYING, MULCHING, FERTILIZING, ETC.) OF THE PLANTING AREAS AND LAWN UNTIL THE WORK IS ACCEPTED IN TOTAL BY THE OWNER/ENGINEER PER STANDARDS DETAILED IN SPECIFICATION SECTION 32 92 50.
- A SATISFACTORY STAND OF GRASS WHICH IS ACCEPTABLE IS DEFINED AS CONSISTING OF A UNIFORM STAND OF AT LEAST 60% ESTABLISHED, PERMANENT GRASS SPECIES, FREE OF WEED SPECIES AND NO BARE SPOTS (FREE OF GERMINATING GRASS), PER STANDARDS DETAILED IN SPECIFICATION SECTION 32 92 50.
- 10. THE CONTRACTOR SHALL COMPLETELY GUARANTEE ALL PLANT MATERIAL FOR A PERIOD OF ONE (1) YEAR BEGINNING ON THE DATE OF TOTAL ACCEPTANCE. THE CONTRACTOR SHALL PROMPTLY MAKE ALL REPLACEMENTS BEFORE OR AT THE END OF THE GUARANTEE PERIOD.
- 11. AFTER BEING DUG AT THE NURSERY SOURCE, ALL TREES IN LEAF SHALL BE ACCLIMATED FOR TWO (2) WEEKS UNDER A MIST SYSTEM PRIOR TO INSTALLATION.
- 12. ANY PLANT MATERIAL WHICH DIES, TURNS BROWN, OR DEFOLIATES (PRIOR TO TOTAL ACCEPTANCE OF THE WORK) SHALL BE PROMPTLY REMOVED FROM THE SITE AND REPLACED WITH MATERIAL OF THE SAME SPECIES, QUANTITY, AND SIZE AND MEETING ALL PLANT LIST SPECIFICATIONS.
- 13. STANDARDS SET FORTH IN "AMERICAN STANDARD FOR NURSERY STOCK" REPRESENT GUIDELINE SPECIFICATIONS ONLY AND SHALL CONSTITUTE MINIMUM QUALITY REQUIREMENTS FOR PLANT MATERIAL
- ALL SHRUB, GROUND COVER AND SEASONAL COLOR ANNUAL PLANTING BEDS ARE TO BE COMPLETELY COVERED WITH HARDWOOD MULCH TO A MINIMUM DEPTH OF FOUR INCHES.



Gale Associates, Inc.
Engineers and Planners

217 N. WESTMONTE DR | SUITE 3033 | ALTAMONTE SPRINGS, FL 32714 P 407.599.7031 F 407.599.7077 www.gainc.com

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SOMERSET TENNIS COMPLEX RENOVATIO
ST. MARY'S COLLEGE OF MARYLAND
COLLEGE DRIVE
ST. MARY'S CITY, MD 20686
ST. MARY'S COLLEGE OF MARYLAND
18952 E. FISHER ROAD
ST. MARY'S CITY, MARYLAND 20686

NO. DATE DESCRIPTION BY
PROJECT NO. 678356

CADD FILE 678356_G001

DESIGNED BY PS/SCR

DRAWN BY SCR

DRAWING SCALE

GRAPHIC SCALE

07/13/2023


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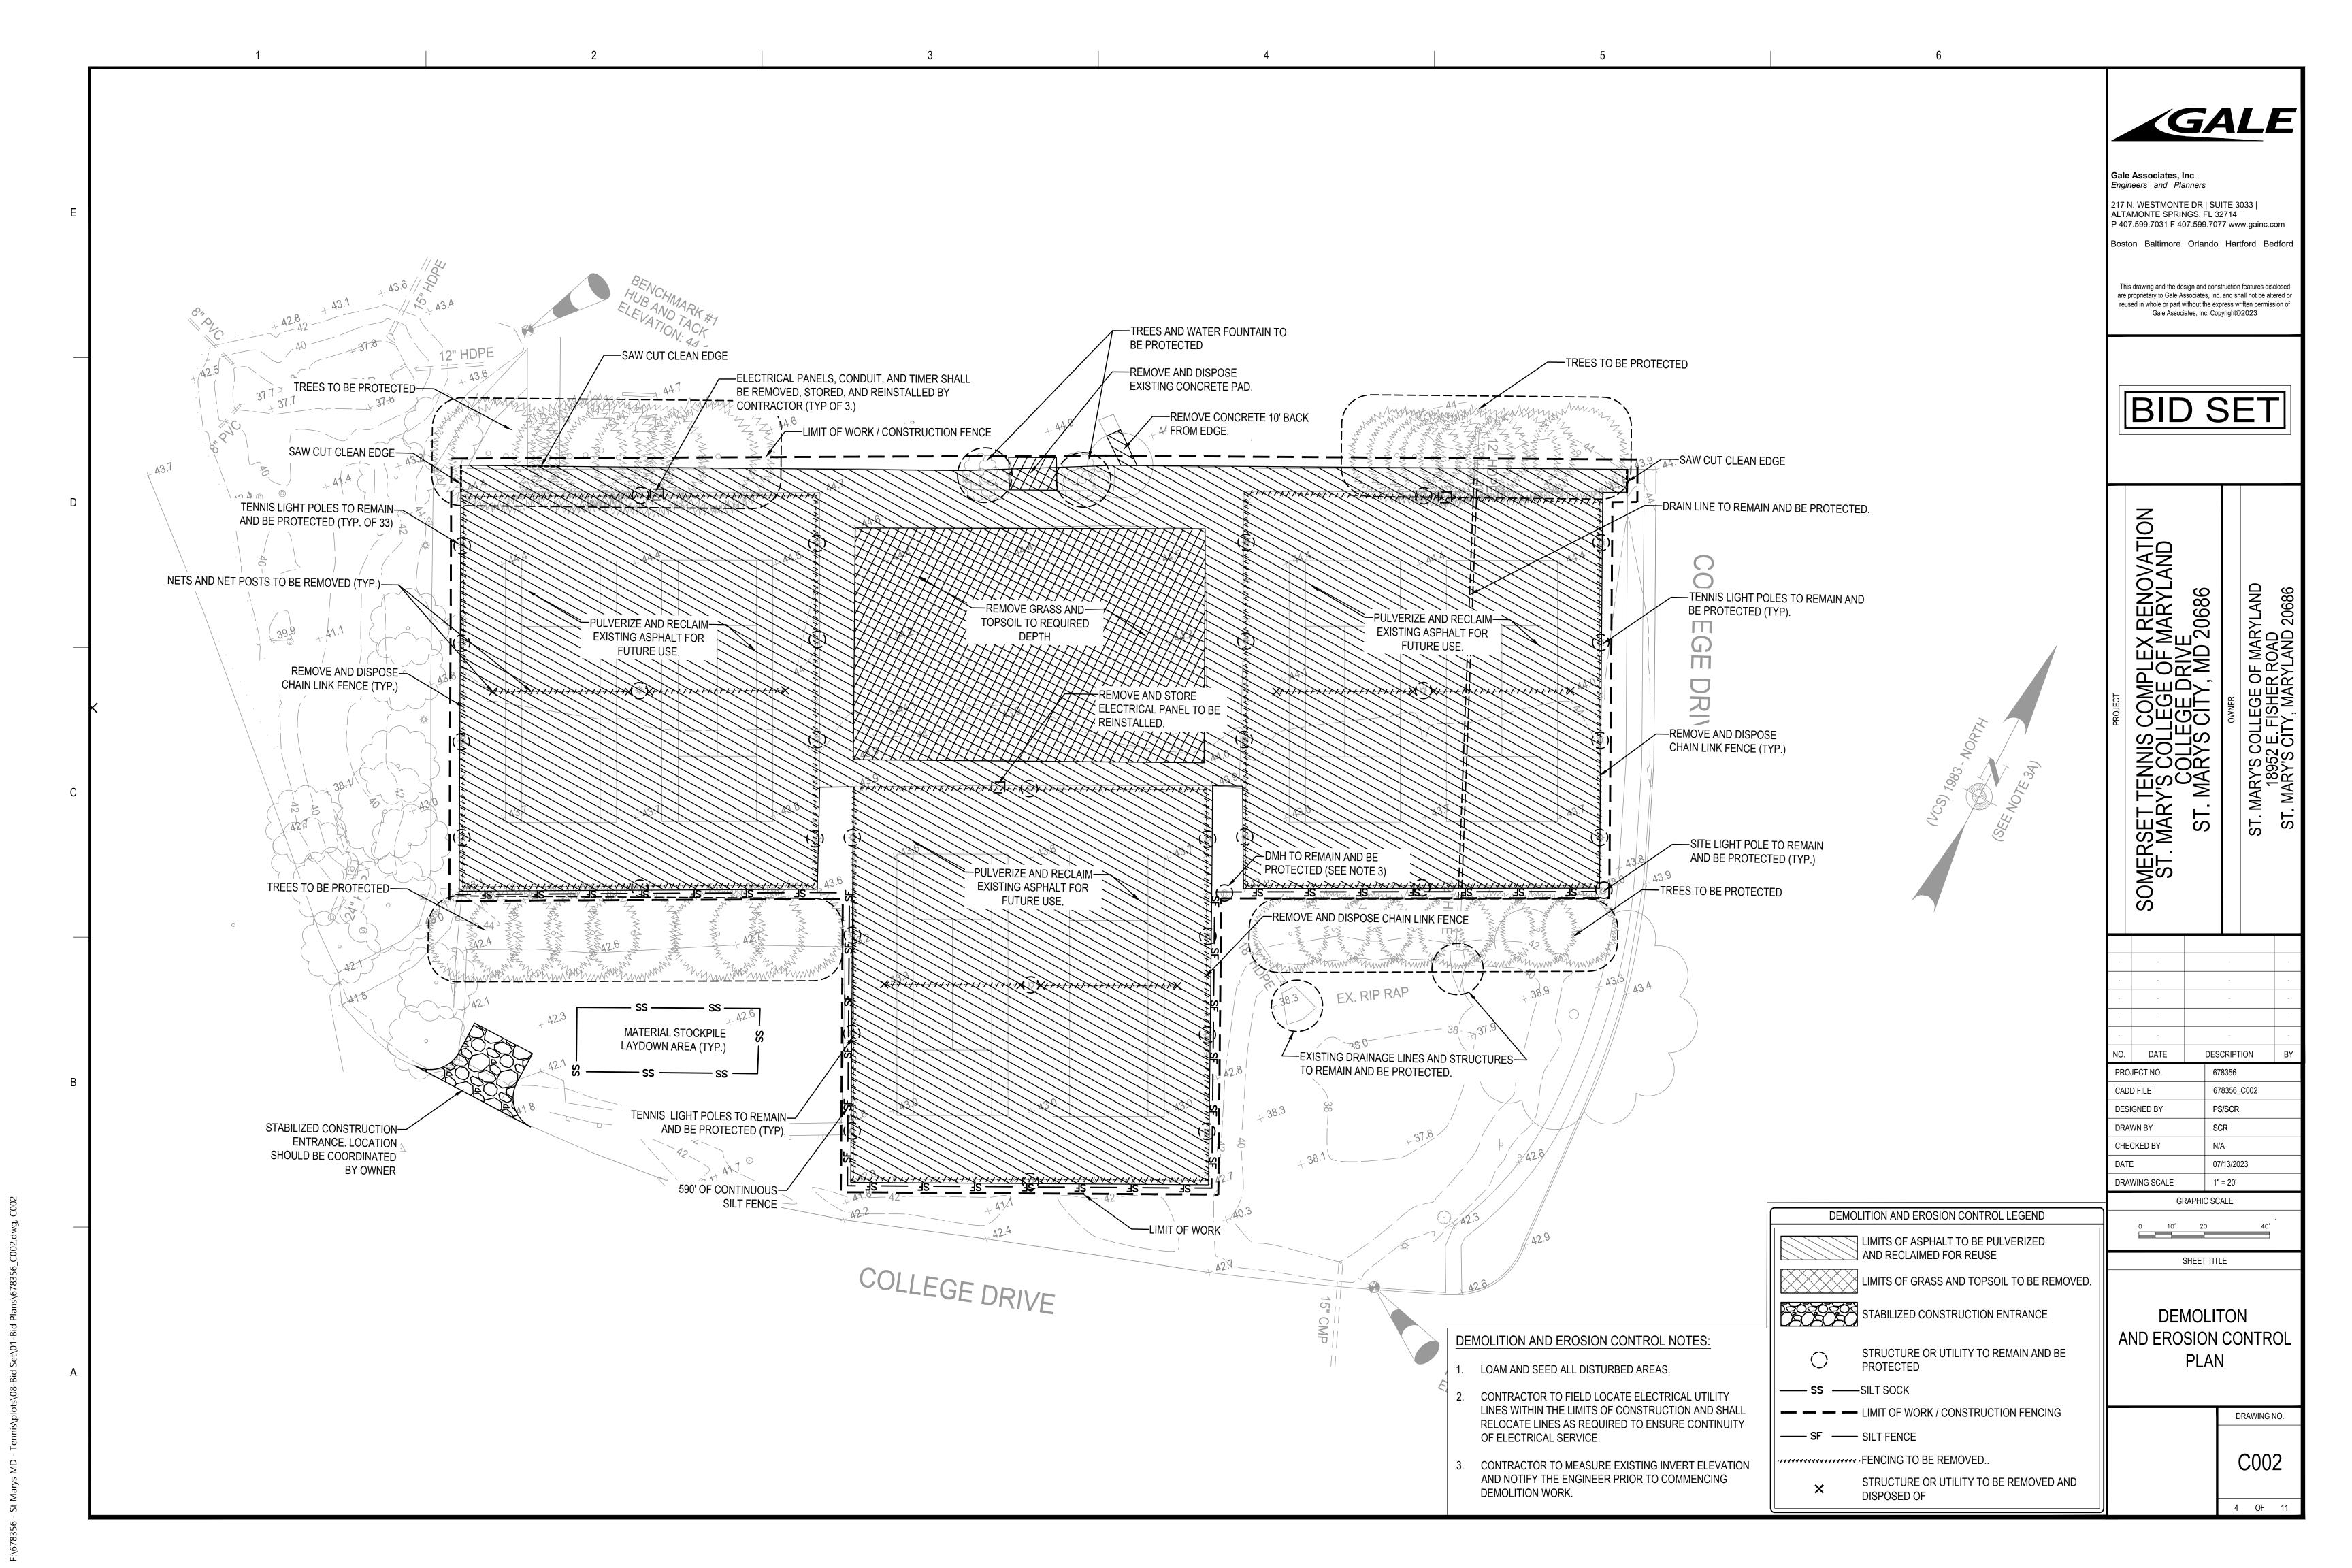
NOTES AND LEGEND


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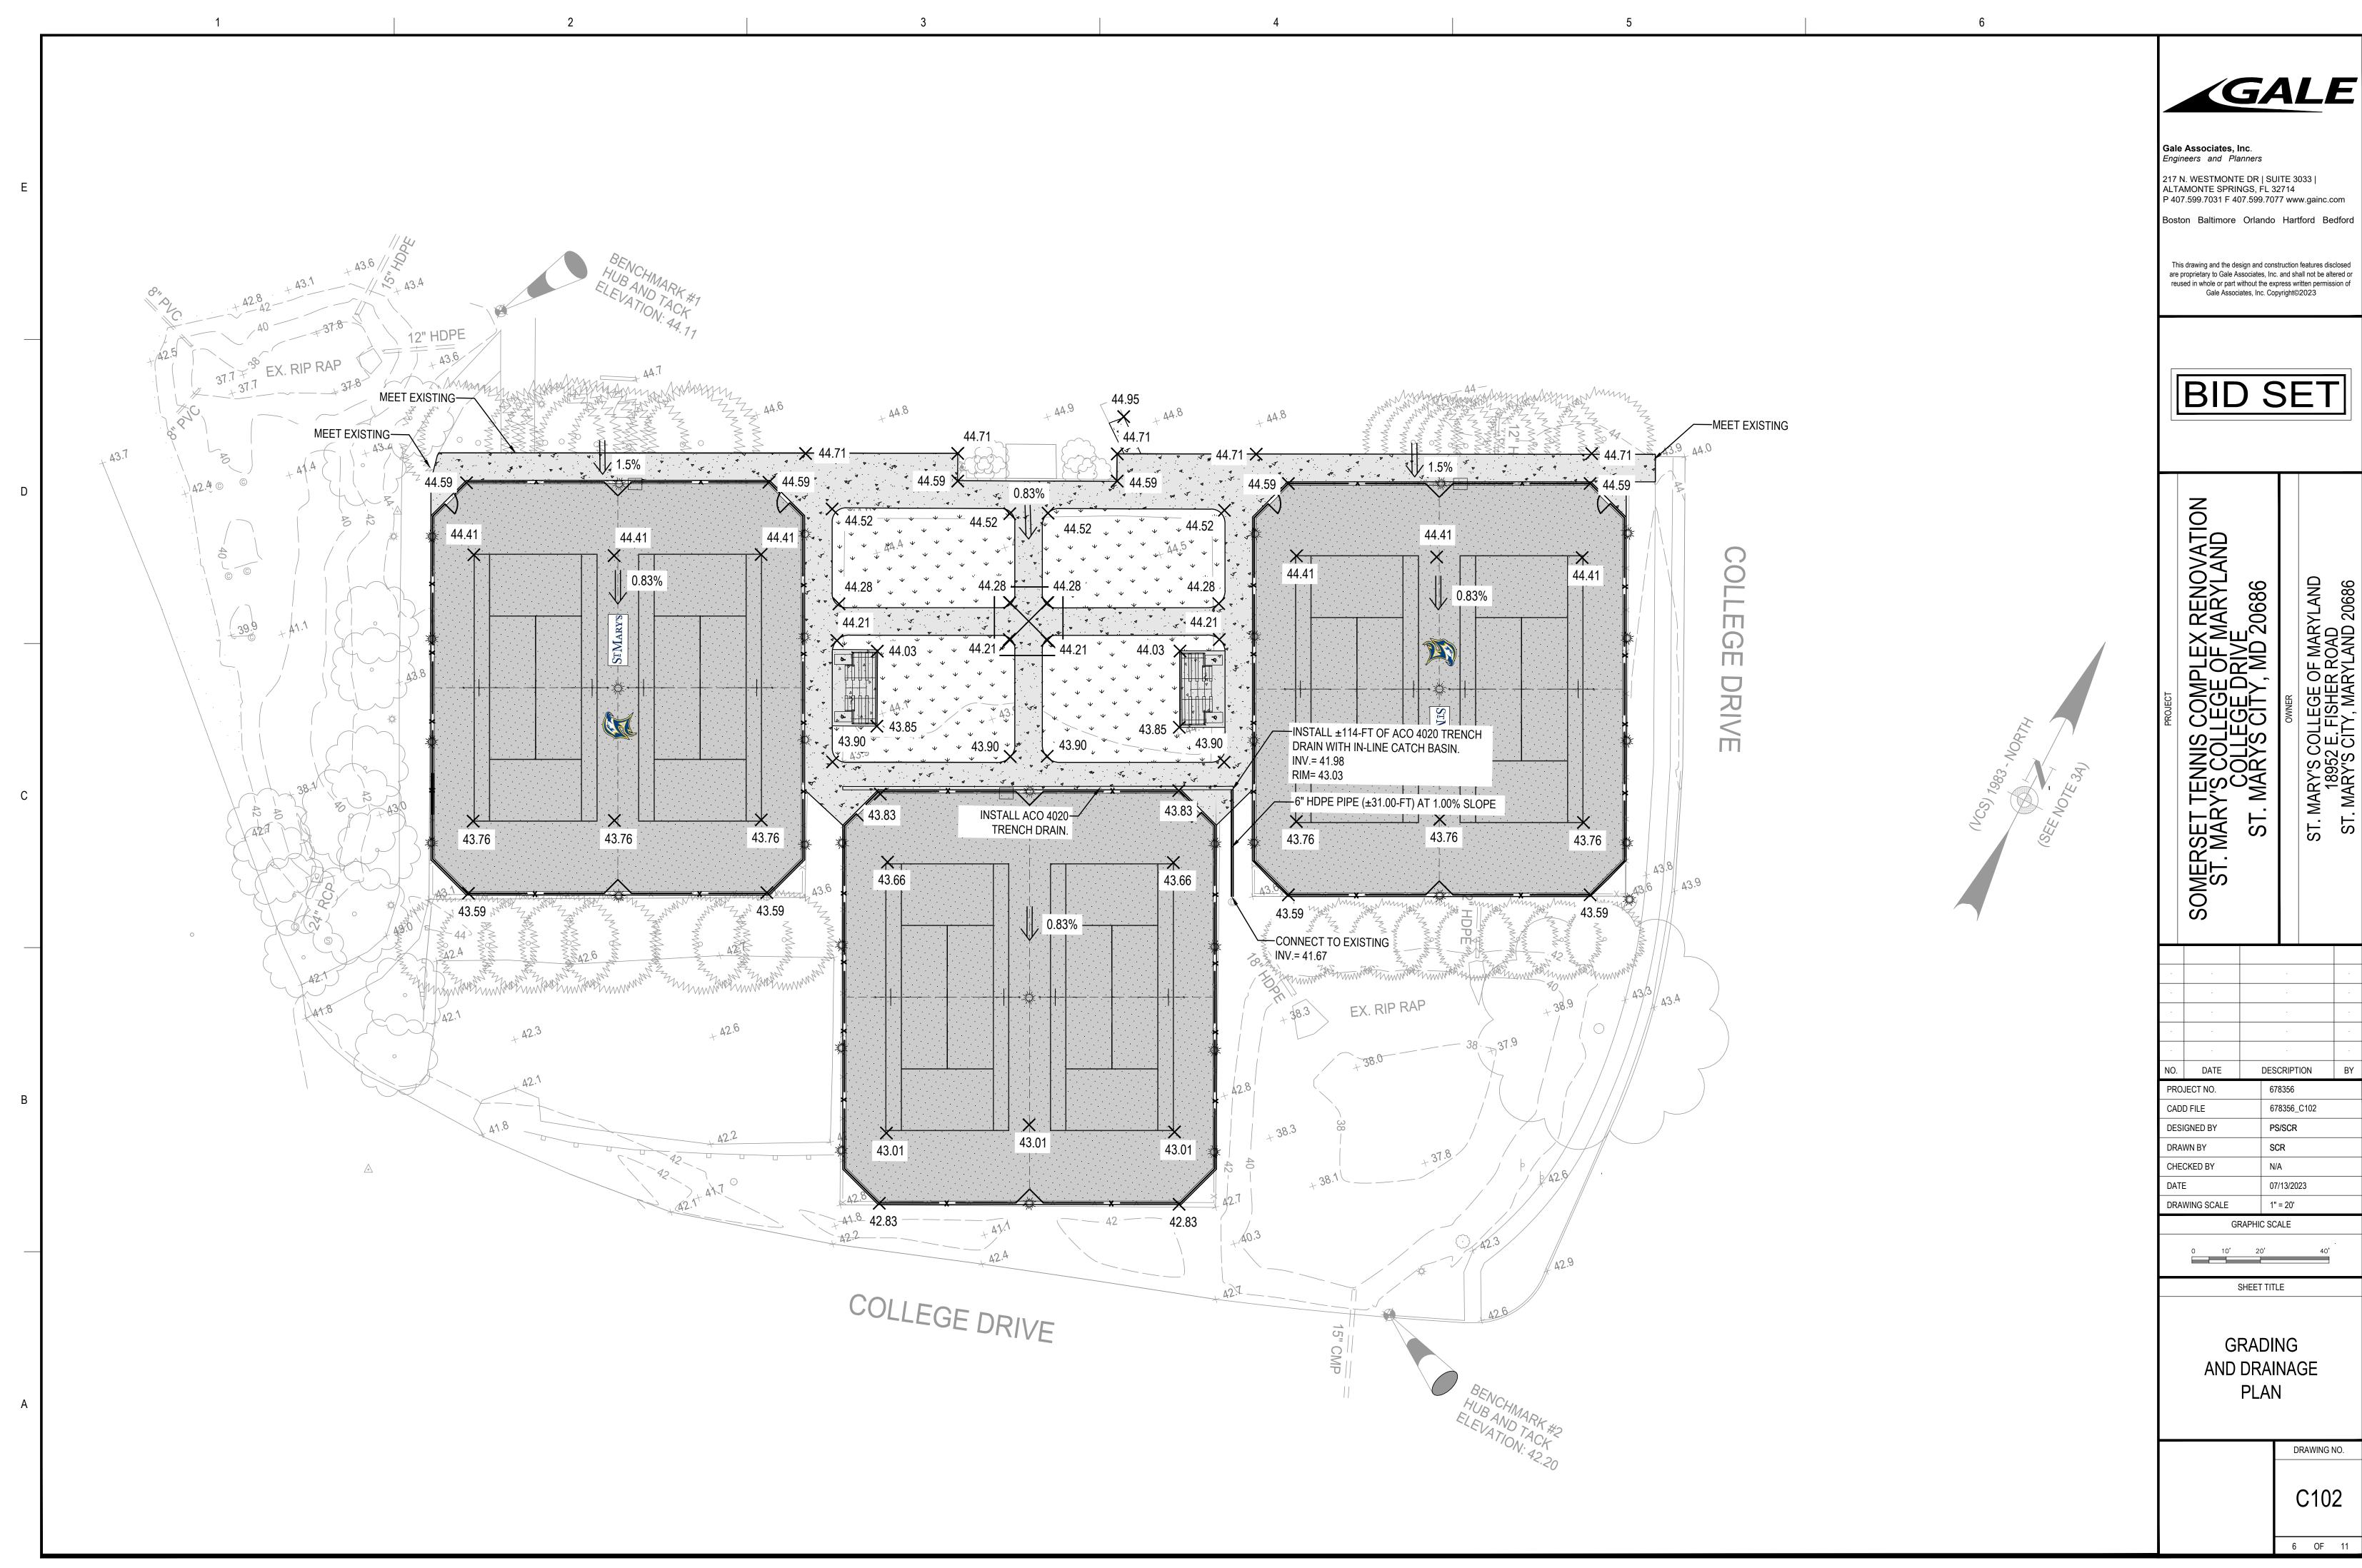



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DETAIL E-1 SILT FENCE ⊢——SF—— 36 IN MIN. FENCE POST LENGTH CENTER TO CENTER DRIVEN MIN. 16 IN INTO GROUND 16 IN MIN. HEIGHT OF WOVEN SLIT FILM GEOTEXTILE KKKKKKKKKKK L8 IN MIN. DEPTH INTO GROUND **ELEVATION** 36 IN MIN. FENCE POST LENGTH FENCE POST 18 IN MIN. — ABOVE GROUND WOVEN SLIT FILM -GEOTEXTILE GROUND KKKKK. VIXIXIXIXIXIXI FENCE POST DRIVEN A MIN. OF 16 IN INTO EMBED GEOTEXTILE THE GROUND MIN. OF 8 IN VERTICALLY INTO THE GROUND. BACKFILL AND COMPACT THE SOIL ON BOTH SIDES OF GEOTEXTILE. CROSS SECTION STEP STEP 2 STAPLE---TWIST POSTS TOGETHER STAPLE-L-STAPLE STAPLE CONFIGURATIO STAPLE-└──STAPLE JOINING TWO ADJACENT SIL FENCE SECTIONS (TOP VIEW) 1 OF 2 MARYLAND STANDARDS AND SPECIFICATIONS FOR SOIL EROSION AND SEDIMENT CONTROL U.S. DEPARTMENT OF AGRICULTURE MARYLAND DEPARTMENT OF ENVIRONMENT

STANDARD SYMBOL

WATER MANAGEMENT ADMINISTRATION

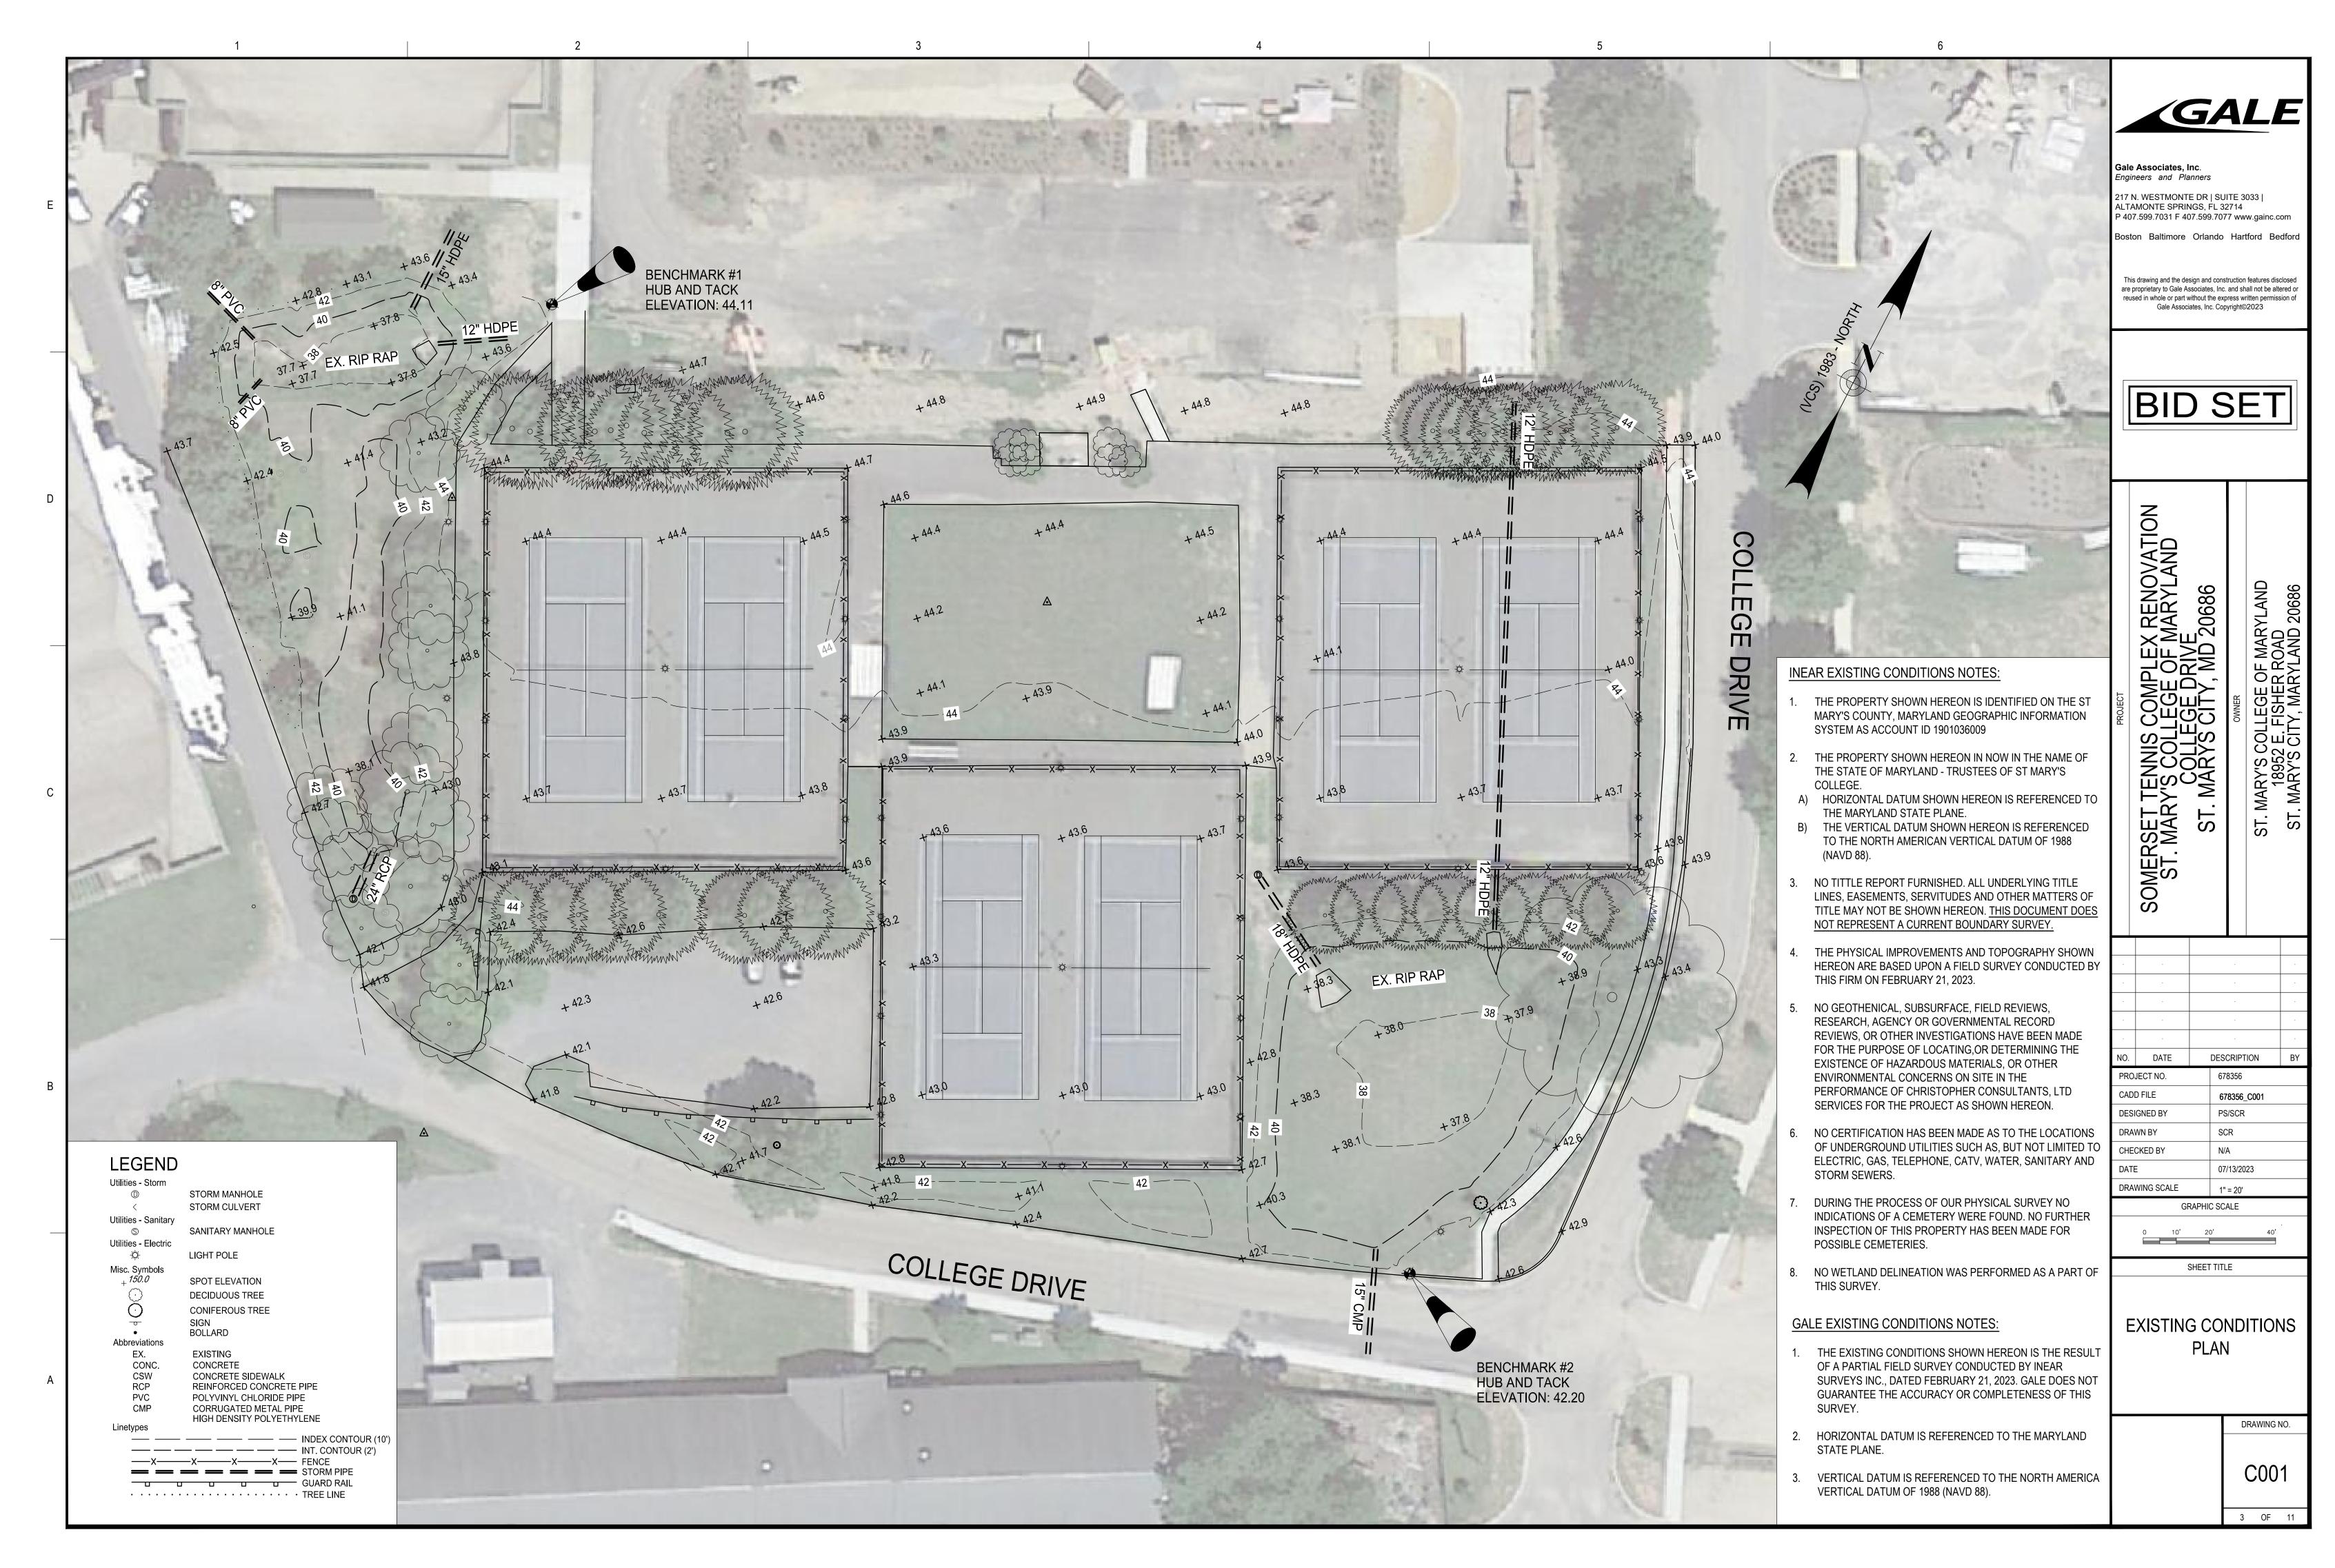DETAIL E-1 SILT FENCE ⊢----SF------CONSTRUCTION SPECIFICATIONS 1. USE WOOD POSTS $1\frac{3}{4}$ X $1\frac{3}{4}$ \pm $\frac{1}{16}$ INCH (MINIMUM) SQUARE CUT OF SOUND QUALITY HARDWOOD. AS AN ALTERNATIVE TO WOODEN POST USE STANDARD "T" OR "U" SECTION STEEL POSTS WEIGHING NOT LESS THAN 1 POUND PER LINEAR FOOT. 2. USE 36 INCH MINIMUM POSTS DRIVEN 16 INCH MINIMUM INTO GROUND NO MORE THAN 6 FEET APART. 3. USE WOVEN SLIT FILM GEOTEXTILE AS SPECIFIED IN SECTION H-1 MATERIALS AND FASTEN GEOTEXTILE SECURELY TO UPSLOPE SIDE OF FENCE POSTS WITH WIRE TIES OR STAPLES AT TOP AND MID-SECTION. 4. PROVIDE MANUFACTURER CERTIFICATION TO THE AUTHORIZED REPRESENTATIVE OF THE INSPECTION/ENFORCEMENT AUTHORITY SHOWING THAT THE GEOTEXTILE USED MEETS THE REQUIREMENTS IN SECTION H-1 MATERIALS. 5. EMBED GEOTEXTILE A MINIMUM OF 8 INCHES VERTICALLY INTO THE GROUND. BACKFILL AND COMPACT THE SOIL ON BOTH SIDES OF FABRIC. 6. WHERE TWO SECTIONS OF GEOTEXTILE ADJOIN: OVERLAP, TWIST, AND STAPLE TO POST IN ACCORDANCE WITH THIS DETAIL. 7. EXTEND BOTH ENDS OF THE SILT FENCE A MINIMUM OF FIVE HORIZONTAL FEET UPSLOPE AT 45 DEGREES TO THE MAIN FENCE ALIGNMENT TO PREVENT RUNOFF FROM GOING AROUND THE ENDS OF THE SILT FENCE. 8. REMOVE ACCUMULATED SEDIMENT AND DEBRIS WHEN BULGES DEVELOP IN SILT FENCE OR WHEN SEDIMENT REACHES 25% OF FENCE HEIGHT. REPLACE GEOTEXTILE IF TORN. IF UNDERMINING OCCURS, REINSTALL FENCE.

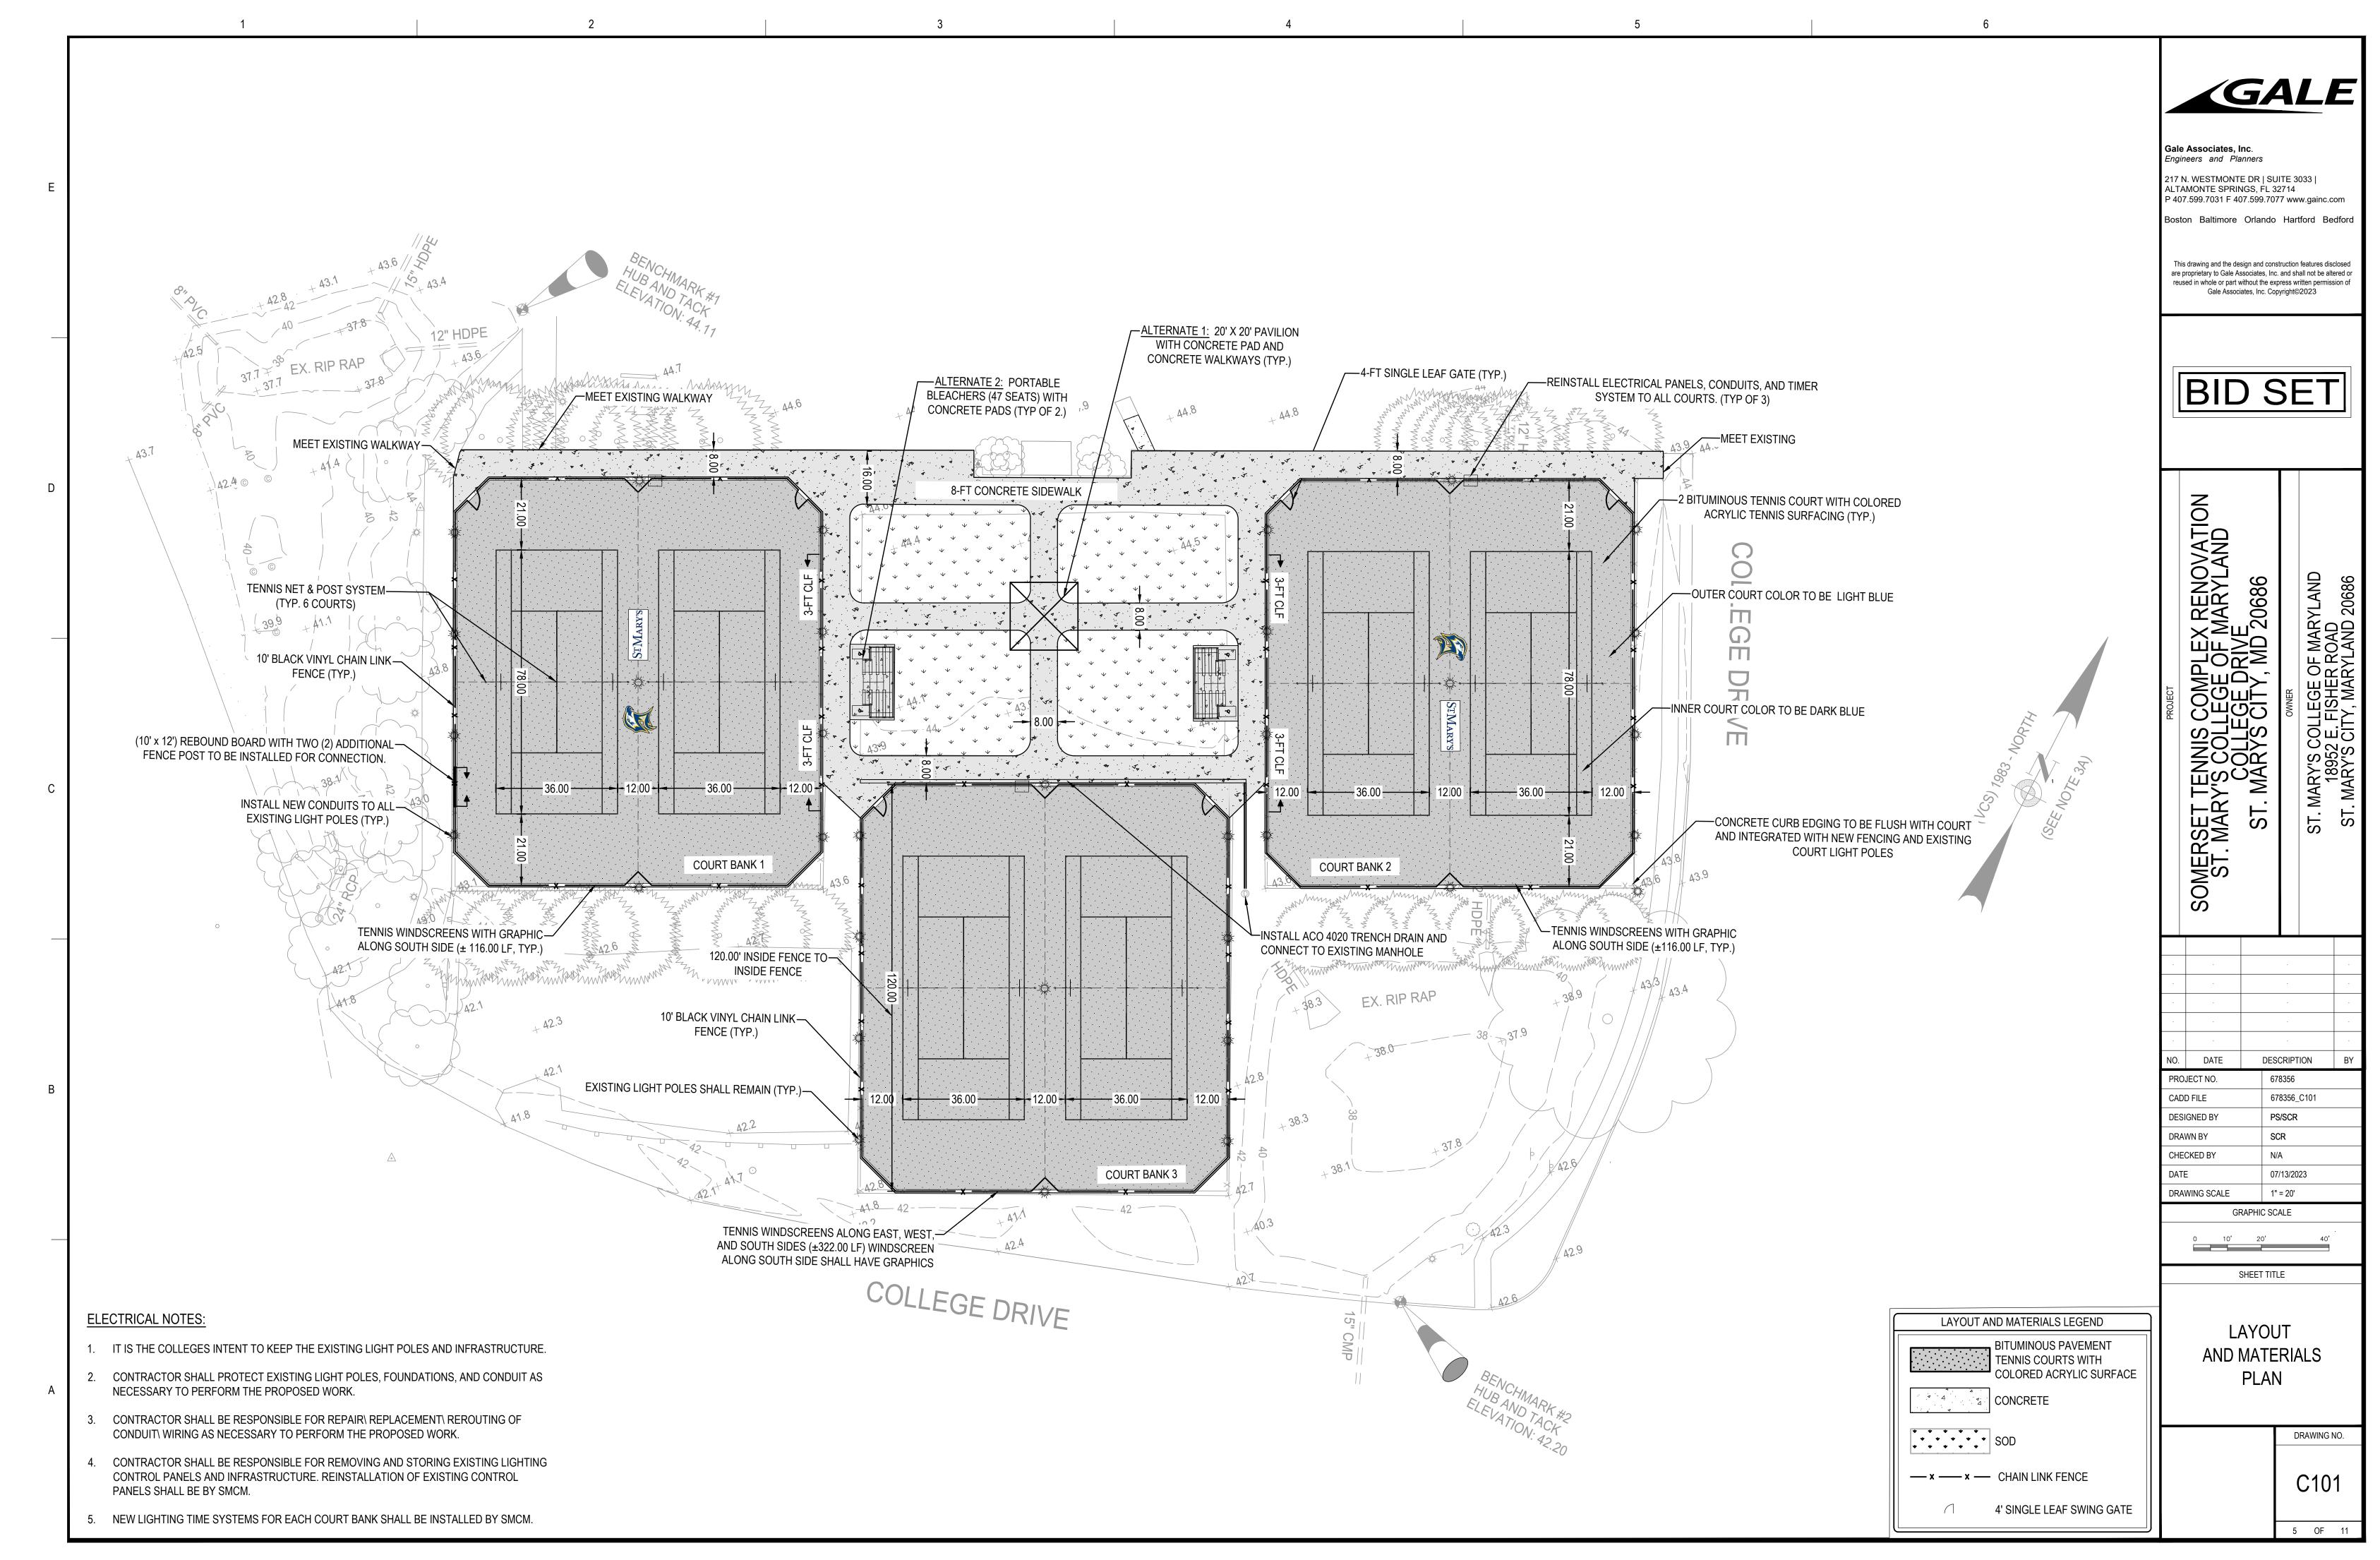MARYLAND STANDARDS AND SPECIFICATIONS FOR SOIL EROSION AND SEDIMENT CONTROL

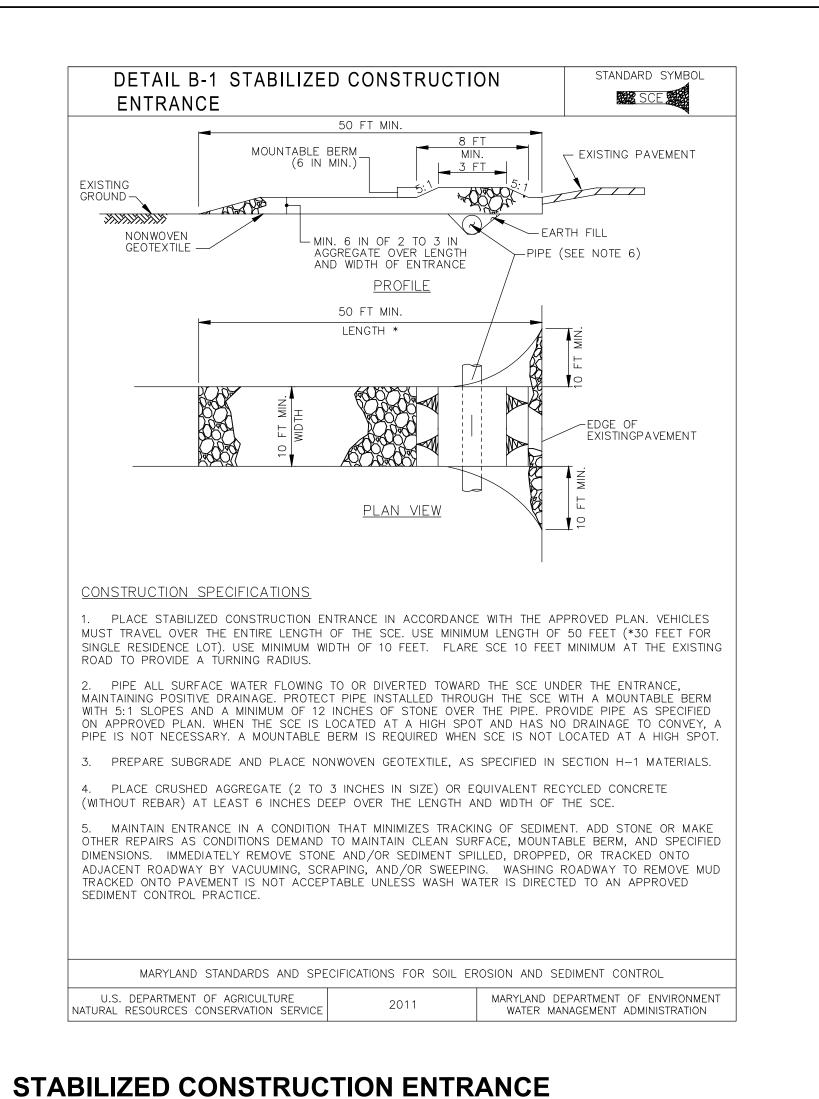U.S. DEPARTMENT OF AGRICULTURE

NATURAL RESOURCES CONSERVATION SERVICE

STANDARD SYMBOL

2 OF 2


MARYLAND DEPARTMENT OF ENVIRONMENT

WATER MANAGEMENT ADMINISTRATION

N.T.S.

SILTATION FENCE

NATURAL RESOURCES CONSERVATION SERVICE

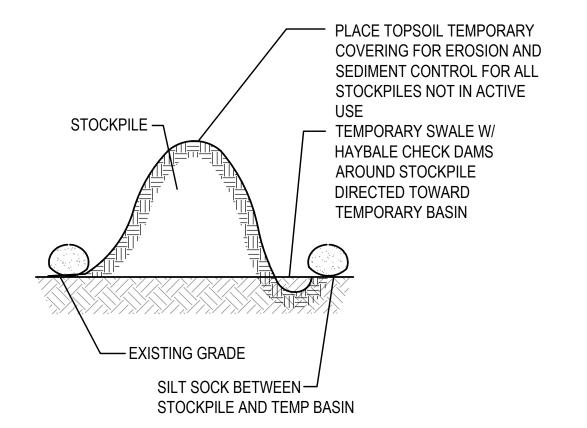

TOPSOIL AND SEEDING DETAIL (DISTURBED AREAS)

SOMERSET ST. MA DESCRIPTION NO. DATE

S.

ST

Gale Associates, Inc.

Engineers and Planners

217 N. WESTMONTE DR | SUITE 3033 |

P 407.599.7031 F 407.599.7077 www.gainc.com

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PROJECT NO. 678356 CADD FILE 678356_C500 PS/SCR DESIGNED BY DRAWN BY SCR CHECKED BY N/A 07/13/2023 DRAWING SCALE N.T.S.

GRAPHIC SCALE

SHEET TITLE

DETAIL SHEET 1 OF 5

> DRAWING NO. C501


> > **7** OF 11

MATERIAL STOCKPILE AREA

FINISH GRADE ———

COMPACTED SUBGRADE —

└─ TOP SOIL

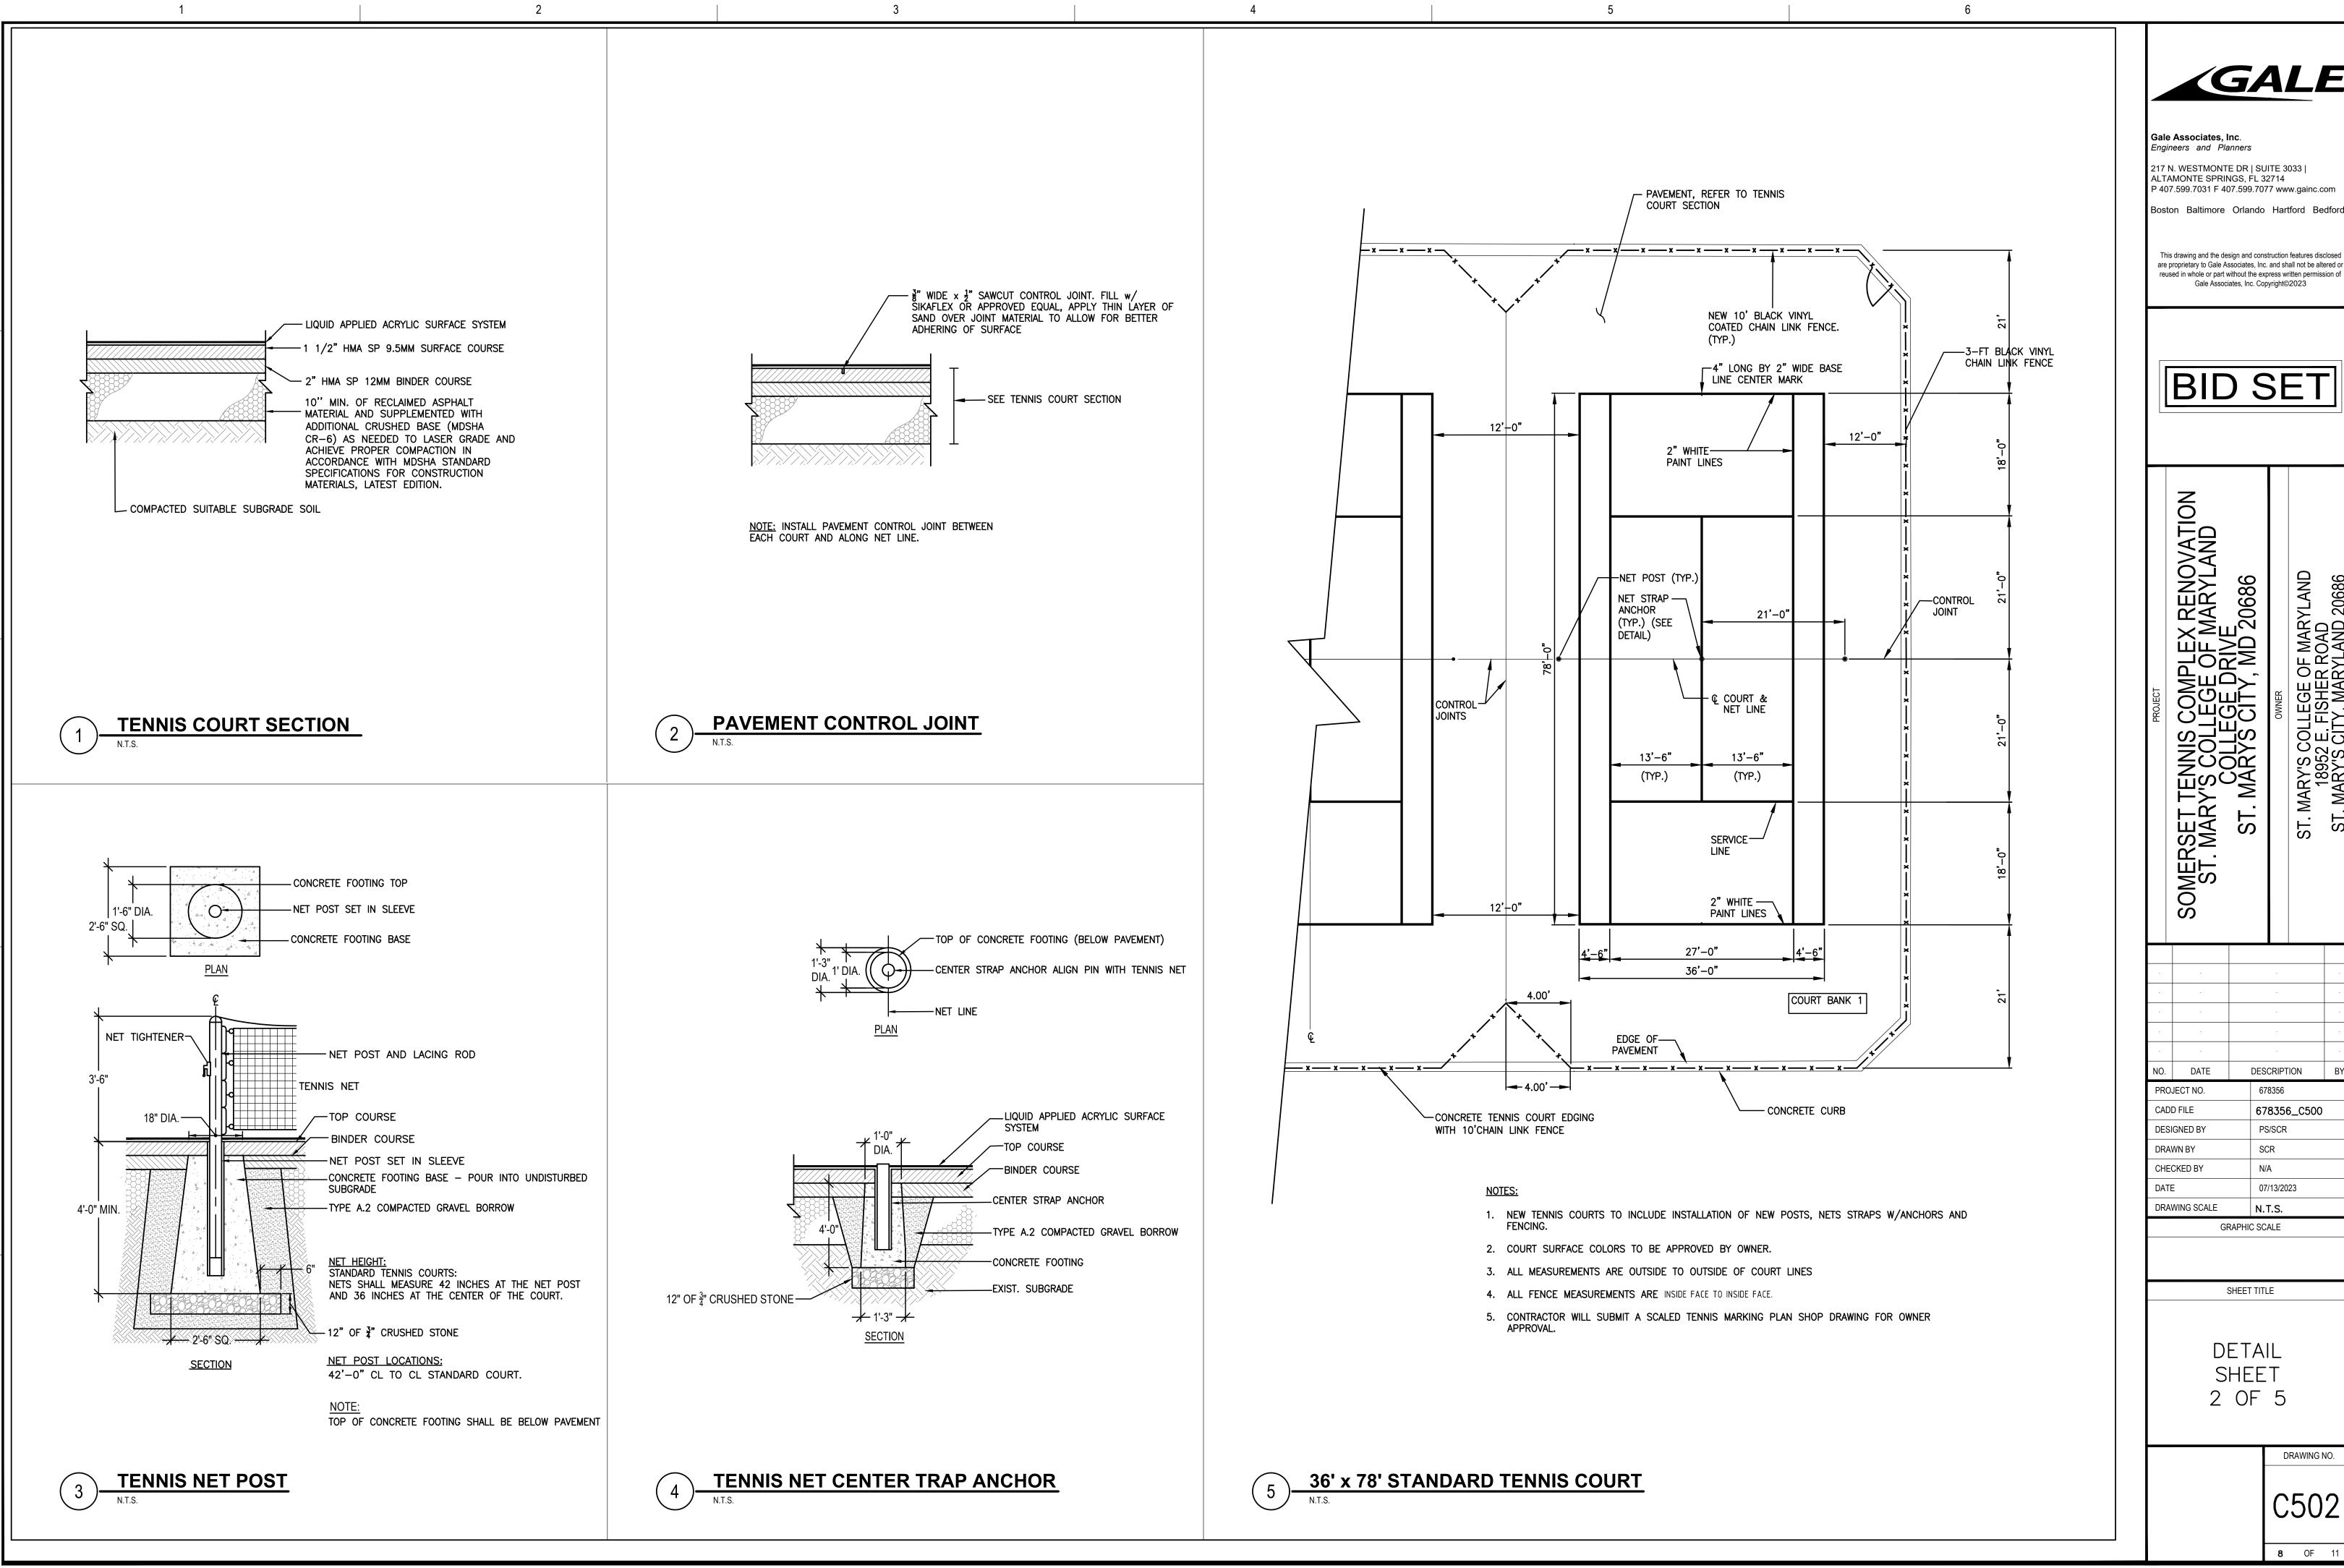

GALE

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DESCRIPTION

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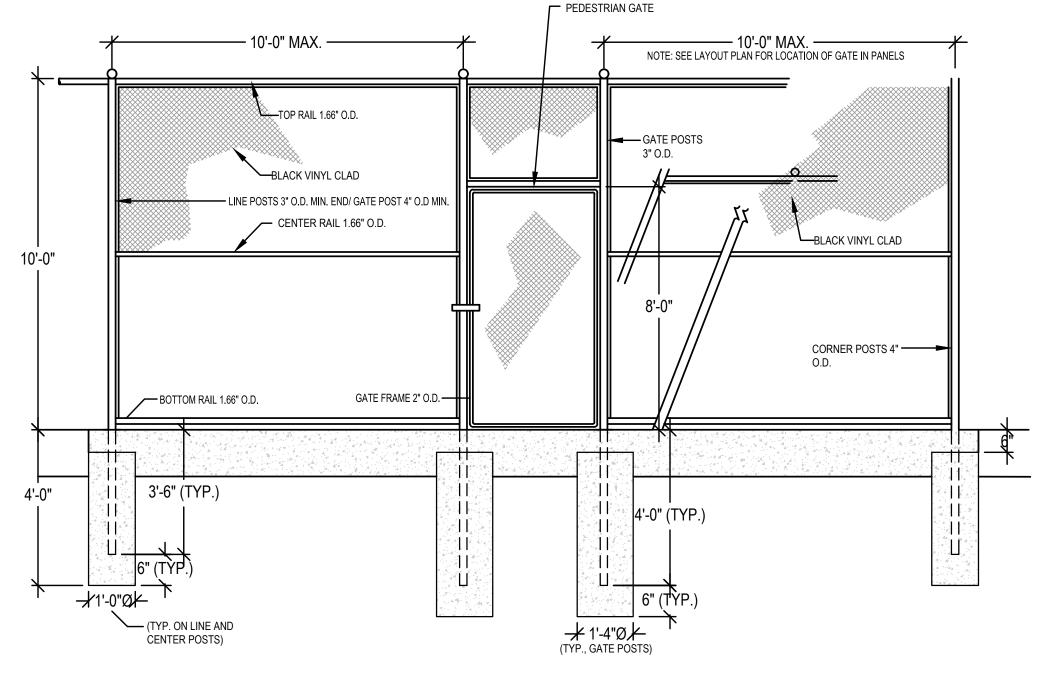
DRAWING NO.

	5	SINGLE OR DOUBLE LEAF	GATES
N	OM HEIGHT (H)	UPRIGHT HT (U)	FRAME HT (F)
		ACTUAL DIM	ACTUAL DIM
	4'-0"	3'-10"	3'-8 1/2"
	6'-0"	5'-10"	5'-8 1/2"
	8'-0"	7'-10"	7'-8 1/2"
	10'-0"	9'-10"	9'-8 1/2"


SINGLE LEAF GATES				
OPENING	GATE POSTS	HINGE SPACE (S)		
FACE TO FACE	SQ & RND SIZES	POST TO UPRIGHT		
3'-0" THROUGH 6'-0"	2 1/2" SQ. OR 2 7/8" O.D.	FOR SQUARE & ROUND GATE POSTS: 2 1/4" [57MM]		

DOUBLE LEAF GATES				
OPENING	GATE POSTS	HINGE SPACE (S)		
FACE TO FACE	SQ & RND SIZES	POST TO UPRIGHT		
14'-0" THROUGH 24'-0"	3" SQ. OR 4" O.D.	FOR SQUARE & ROUND GATE POSTS 2 1/4" [57MM]		

- 1. ALL CHAIN LINK FENCE FABRIC SHALL BE KNUCKLED (TOP AND BOTTOM).
- 2. ALL CHAIN LINK FENCE POSTS, FABRIC, TIES AND MATERIALS SHALL BE BLACK POWDER COATED.
- 3. CENTER UPRIGHT REQUIRED ON GATE LEAVES 8'-0" & WIDER. CENTER RAIL REQUIRED ON GATE LEAVE 6'-0" & HIGHER.
- 4. CONCRETE FOOTINGS SHALL BE FOUR (4) x THE POST DIAMETER, OR AS DESIGNATED ON INDIVIDUAL DETAILS.
- 5. FABRIC OPENINGS FOR TENNIS COURTS SHALL BE 1.75-INCHES



- 1. EACH OF THE PEDESTRIAN GATES SHALL CONTAIN A FROST-FREE LATCH ASSEMBLY WITHOUT DROP RODS, INCLUDING LOCKS AND THREE (3) SETS OF KEYS.
- PRIOR TO INSTALLATION CONTRACTOR/ FENCING MANUFACTURER SHALL SUBMIT ENGINEERED SHOP DRAWINGS OF FENCE AND FOUNDATIONS IN ACCORDANCE WITH STATE AND LOCAL REGULATIONS.

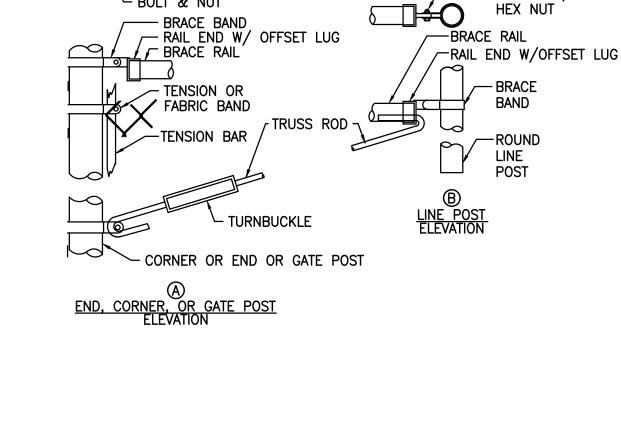

- BRACE RAIL

LOOP CAP


ø BOLT W/

HEX NUT

BRACE RAIL

CHAIN LINK FENCE & GATE CONNECTION DETAIL


10 FOOT HIGH CHAIN LINK FENCE

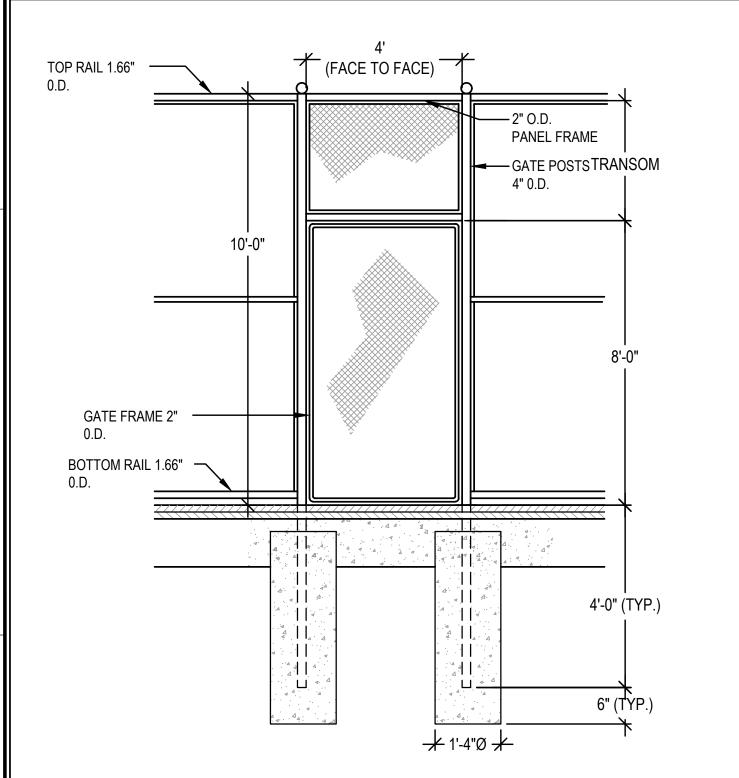


CHAIN LINK FENCE & GATE NOTES

GATE HEIGHT SHALL BE 8'-0" WITH TRANSOM FOR 10'-0" HIGH FENCING. PRIOR TO INSTALLATION CONTRACTOR/ FENCING MANUFACTURER SHALL SUBMIT ENGINEERED SHOP DRAWINGS OF FENCE AND FOUNDATIONS IN ACCORDANCE WITH STATE AND LOCAL

SINGLE LEAF GATE

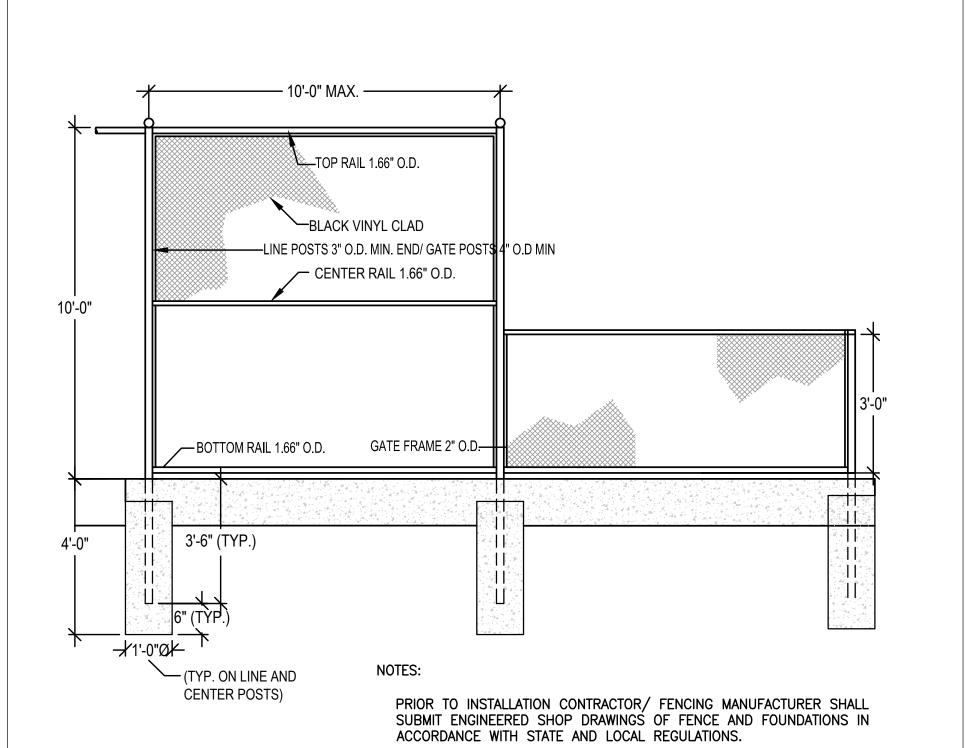

3 FOOT HIGH CHAIN LINK FENCE

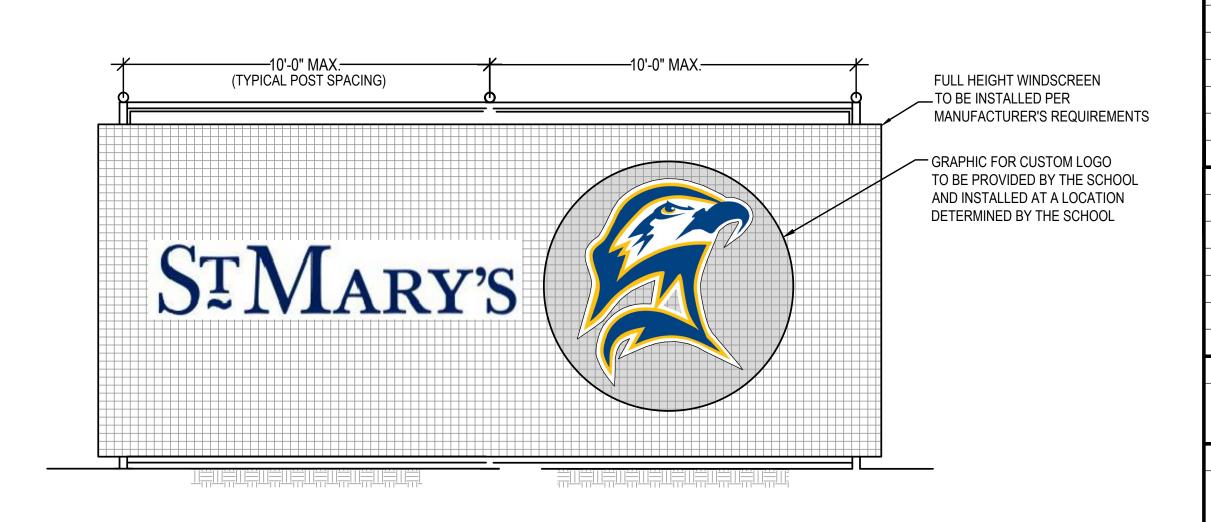

WINDSCREEN LOGOS SHALL BE PROVIDED ALONG THE SOUTHER FENCE FOR EACH COURT (TOTAL OF 6 LOGOS).

MARY'S TENNIS" LETTERING.

EACH LOGO SHALL INCLUDE A SEAHAWAK HEAD AND "ST.

TENNIS COURT WINDSCREEN

GALE

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EX RENOVATION OF MARYLAND NVE SOMERSET ST. MAI ST S


NO. DATE DESCRIPTION PROJECT NO. 678356 CADD FILE 678356_C500 PS/SCR DESIGNED BY DRAWN BY SCR CHECKED BY N/A 07/13/2023

DRAWING SCALE N.T.S. GRAPHIC SCALE


SHEET TITLE

DETAIL SHEET 3 OF 5

> DRAWING NO. C503

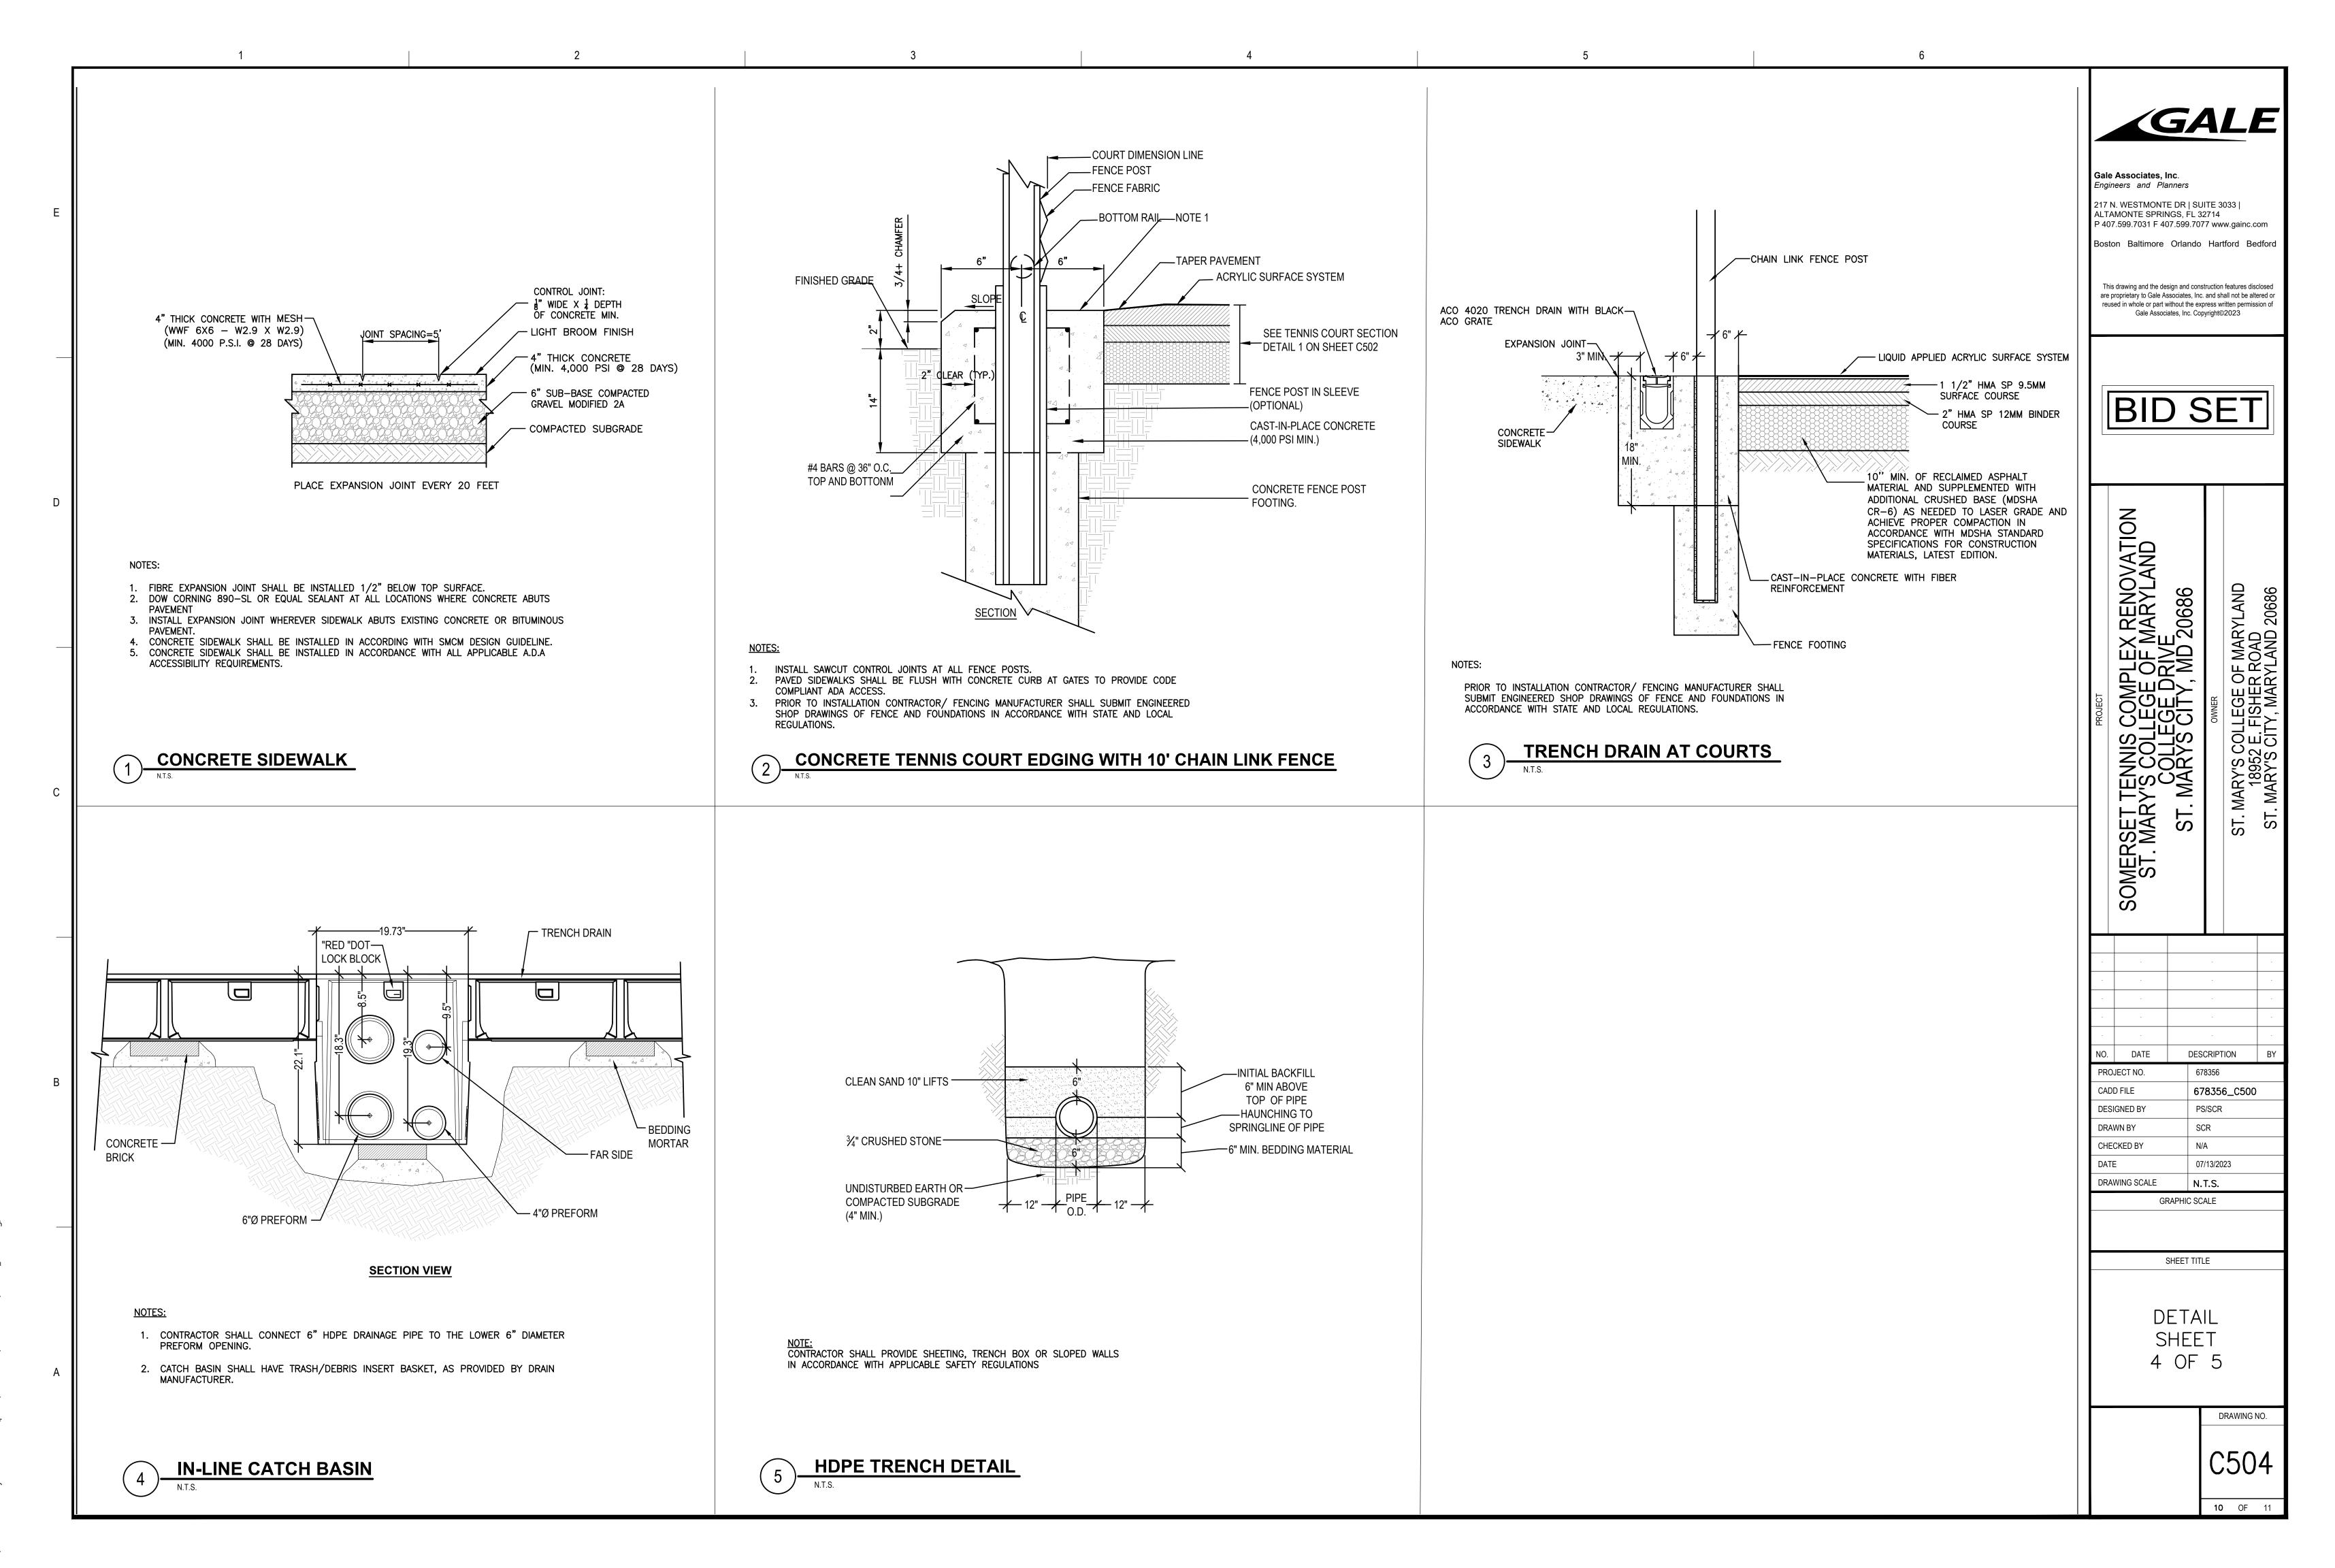

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A. BASIS OF DESIGN FOR PAVILION IS NAVAJOS SHELTER AS MANUFACTURED BY AMERICANA BUILDING PRODUCT, OR EQUAL

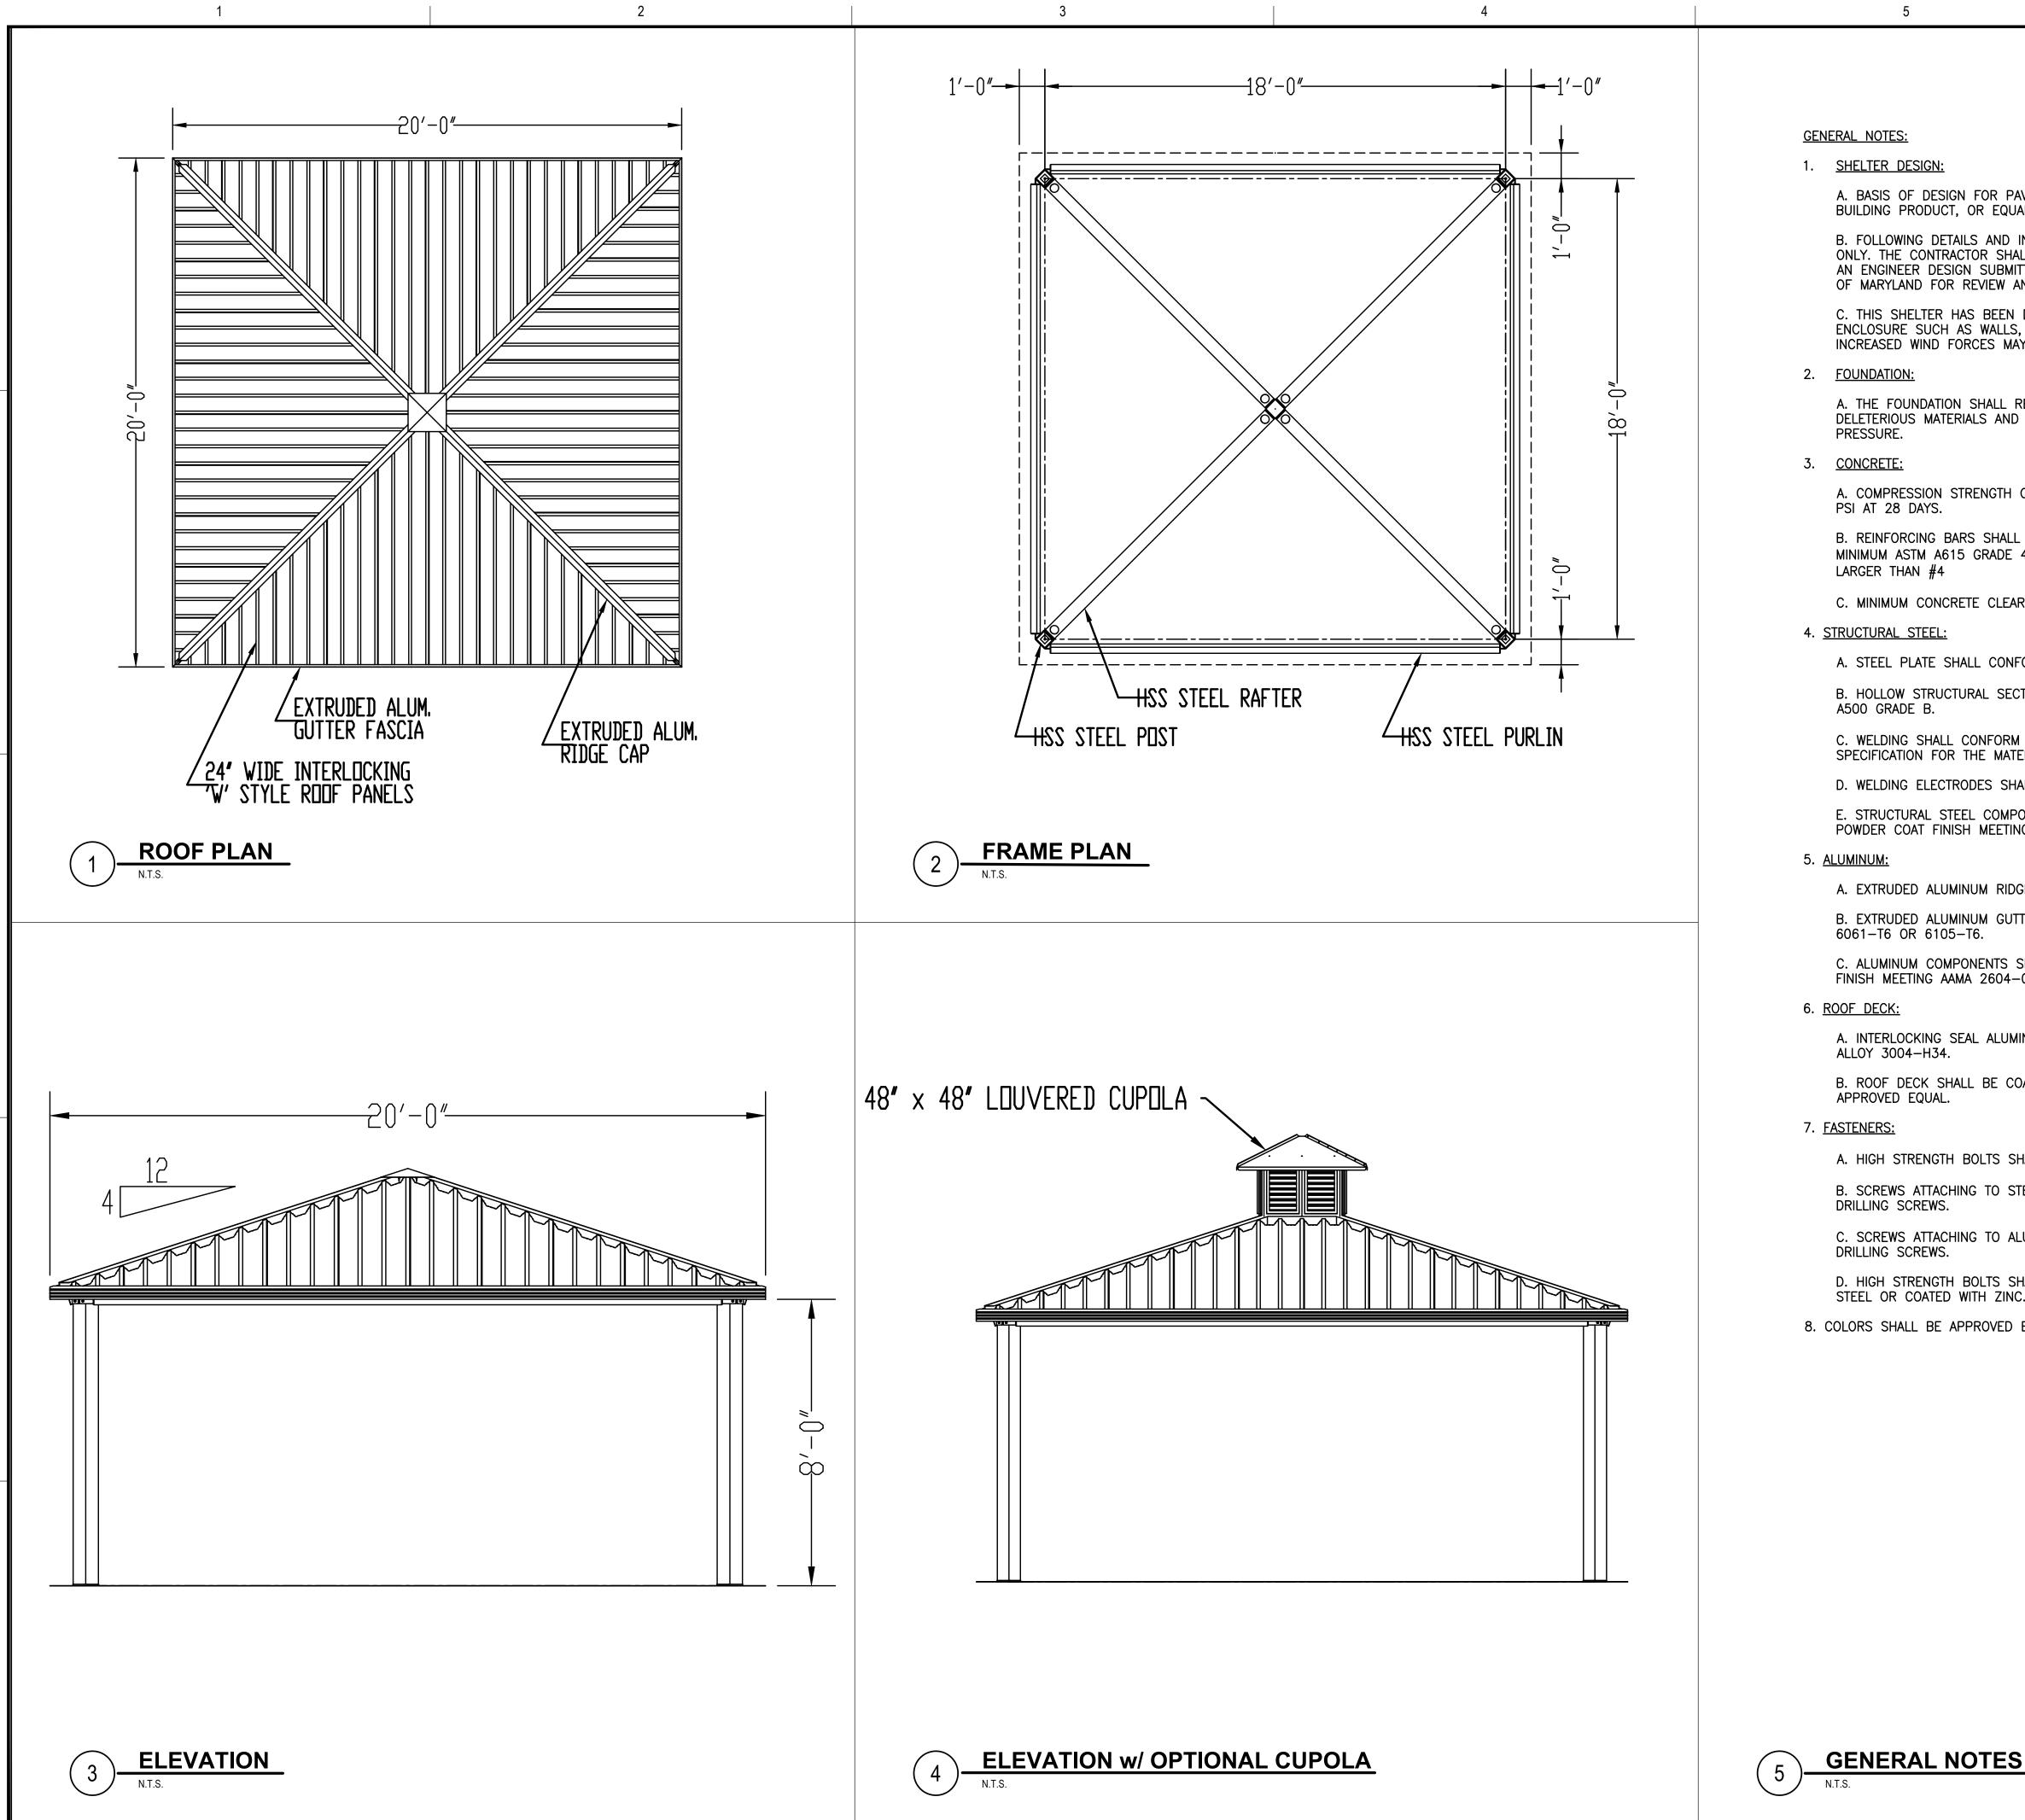B. FOLLOWING DETAILS AND INFORMATION SHOWN IS PROVIDED FOR GENERAL REFERENCE ONLY. THE CONTRACTOR SHALL BE RESPONSIBLE TO COORDINATE WITH VENDOR AND PROVIDE AN ENGINEER DESIGN SUBMITTAL OF STAMPED BY A PROFESSIONAL ENGINEER IN THE STATE OF MARYLAND FOR REVIEW AND APPROVAL BY OWNER.

C. THIS SHELTER HAS BEEN DESIGNED AS AN OPEN STRUCTURE. THE ADDITION OF ANY ENCLOSURE SUCH AS WALLS, INSECT, MESH, OR SHADE SCREENS SHALL BE PROHIBITED AS INCREASED WIND FORCES MAY RESULT.

A. THE FOUNDATION SHALL REST ON SOUND SOIL THAT IS FREE OF ORGANIC AND DELETERIOUS MATERIALS AND CAPABLE OF SUPPORTING 1000 PSF VERTICAL BEARING

A. COMPRESSION STRENGTH OF ALL REINFORCED CONCRETE SHALL NOT BE LESS THAN 4,000

B. REINFORCING BARS SHALL BE DEFORMED BARS CONFORMING TO THE REQUIREMENTS OF MINIMUM ASTM A615 GRADE 40 FOR #4 AND SMALLER BARS AND GRADE 60 FOR BARS

C. MINIMUM CONCRETE CLEAR COVER FOR REINFORCING BARS SHALL BE 3'.

A. STEEL PLATE SHALL CONFORM TO THE REQUIREMENTS OF ASTM A36.

B. HOLLOW STRUCTURAL SECTIONS (HSS) SHALL CONFORM TO THE REQUIREMENTS OF ASTM

C. WELDING SHALL CONFORM TO THE REQUIREMENTS OF THE AMERICAN WELDING SOCIETY'S SPECIFICATION FOR THE MATERIAL BEING WELDED.

D. WELDING ELECTRODES SHALL BE E70XX.

E. STRUCTURAL STEEL COMPONENTS SHALL BE COATED WITH ANTI-GRAFFITI POLYESTER POWDER COAT FINISH MEETING AAMA 2604-02 SPECIFICATION.

A. EXTRUDED ALUMINUM RIDGE CAP SHALL BE FABRICATED FROM ALUMINUM ALLOY 6105-T5.

B. EXTRUDED ALUMINUM GUTTER FASCIA AND FASCIA TRIM SHALL BE FABRICATED FROM ALLOY 6061-T6 OR 6105-T6.

C. ALUMINUM COMPONENTS SHALL BE COATED WITH ANTI-GRAFFITI POLYESTER POWDER COAT FINISH MEETING AAMA 2604-02 SPECIFICATION.

A. INTERLOCKING SEAL ALUMINUM ROOF DECK SHALL BE ROLL FORMED FROM ALUMINUM

B. ROOF DECK SHALL BE COATED WITH HEAT REFLECTIVE BASF ULTRA-COOL COATING OR

A. HIGH STRENGTH BOLTS SHALL CONFORM TO ASTM A325 OR A307 (SEE DETAILS).

B. SCREWS ATTACHING TO STEEL SHALL BE 12-24 HEX WASHER HEAD #5 POINT SELF

C. SCREWS ATTACHING TO ALUMINUM SHALL BE 8-18 HEX WASHER HEAD #2 POINT SELF

D. HIGH STRENGTH BOLTS SHALL BE HOT DIP GALVANIZED. ALL SCREWS SHALL BE STAINLESS STEEL OR COATED WITH ZINC.

8. COLORS SHALL BE APPROVED BY OWNER.



Gale Associates, Inc. Engineers and Planners

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T TENNIS COMPLEX RENOVATION RY'S COLLEGE OF MARYLAND COLLEGE DRIVE T. MARYS CITY, MD 20686 OMERSE ST. MAI ST S

NO. DATE DESCRIPTION

PROJECT NO. 678356 CADD FILE 678356_C500 **DESIGNED BY** PS/SCR DRAWN BY SCR CHECKED BY N/A 07/13/2023 DRAWING SCALE N.T.S.

GRAPHIC SCALE

SHEET TITLE

DETAIL SHEET 5 OF 5

DRAWING NO.

C505