


GENERAL NOTES (THESE NOTES PERTAIN TO ALL CIVIL DRAWINGS)


- EXISTING INFORMATION AND CONDITIONS NOT GUARANTEED; VERIFY AND TEST PIT EXISTING UTILITIES; THE CORRECTNESS AND COMPLETENESS OF THE INFORMATION SHOWING EXISTING CONDITIONS IS NOT GUARANTEED. BEFORE BEGINNING CONSTRUCTION, THE CONTRACTOR SHALL PERFORM THE FOLLOWING TASKS:
 - NOTIFY MISS UTILITY AT 1-800-257-7777, AND MAKE SURE THEY COMPLETE THE MARKING OF UTILITIES WITHIN THE LIMITS OF CONSTRUCTION AT LEAST 48 HOURS PRIOR TO INSTALLING SEDIMENT CONTROL MEASURES. MAINTAIN ALL MARKINGS THROUGHOUT CONSTRUCTION. THE CONTRACTOR SHALL ALSO INCLUDE IN HIS BID PRICE MARKING OF ON-SITE UTILITIES THAT MIGHT NOT BE MARKED BY MISS UTILITY; THE CONTRACTOR SHALL EITHER MARK THESE ON-SITE UTILITIES HIMSELF OR BY SUBCONTRACTING WITH A PRIVATE ON-SITE UTILITY LOCATION COMPANY.
 - VERIFY THE GENERAL ACCURACY OF THE EXISTING CONDITIONS SHOWN ON THE SITE DRAWINGS BY VISUAL INSPECTION OF THE SURFACE OF THE SITE AND ALL EXISTING STRUCTURES, PAVING AND UTILITY APPURTENANCES VISIBLE THEREON;
 - WITH REGARD TO THE STRUCTURES & APPURTENANCES OBSERVED AS REQUIRED PER ITEM (B) ABOVE, DETERMINE THE TYPE, SIZE, LOCATION AND ELEVATION OF ALL THOSE EXISTING UTILITIES (INCLUDING BUT NOT LIMITED TO ALL STORM DRAINS, SANITARY LINES, WATER LINES, GAS LINES, STEAM LINES, ELECTRIC LINES, TELEPHONE LINES, AND COMMUNICATION DUCTS, AND ALL MANHOLES, INLETS, CLEAN-OUTS, VALVES, HANDHOLES, ETC. RELATED THERETO) WITHIN THE LIMITS OF CONSTRUCTION IN ORDER TO: (I) AVOID DAMAGING OR DISRUPTING SERVICE, AND (II) TO COORDINATE AND FACILITATE CONSTRUCTION OF PROPOSED UTILITIES AND OTHER IMPROVEMENTS. IN ADDITION TO THE CONTRACTOR'S VISUAL OBSERVATION AND THE UTILITY MARKING (AS REQUIRED ABOVE), THE CONTRACTOR SHALL SCHEDULE AND COMPLETE TEST PITTING OF ALL EXISTING UTILITIES (FOR THE PURPOSES SET FORTH ABOVE) AND SHALL DO SO IN A TIMELY MANNER IN ORDER TO ALLOW TIME FOR ANALYSIS AND REDESIGN BY SITE RESOURCES AND/OR OTHER CONSULTANTS, WITHOUT DELAYING THE PROJECT SCHEDULE.
 - IMMEDIATELY REPORT TO SITE RESOURCES, INC. THE RESULTS OF STEPS (A), (B) AND (C) WHICH MIGHT INDICATE ANY DISCREPANCY BETWEEN ACTUAL CONDITIONS AND THOSE SHOWN ON THE PLAN, AND ANY POTENTIAL CONFLICTS BETWEEN PROPOSED IMPROVEMENTS AND EXISTING CONDITION.

TEST PITTING DEFINED: FOR THE PURPOSES OF THIS CONTRACT, EXCAVATION OF UTILITY TRENCHES DOES NOT CONSTITUTE TEST PITTING. TEST PITTING IS A SEPARATE OPERATION COMPLETED AT LEAST SEVEN DAYS BEFORE UTILITY INSTALLATION IS SCHEDULED TO BEGIN. TEST PITTING MEANS EXCAVATION TO EXPOSE EXISTING UTILITIES IN TWO SITUATIONS: (I) WHERE PROPOSED IMPROVEMENTS CROSS EXISTING UTILITIES (PIPES, LINES, STRUCTURES, APPURTENANCES) AND, (II) WHERE PROPOSED UTILITIES ARE DESIGNED TO CONNECT TO EXISTING UTILITIES. TEST PITTING INCLUDES RECORDING THE TYPE, SIZE, LOCATION AND ELEVATION OF THE EXPOSED UTILITIES, AND FAXING AND MAILING THE RECORD TO SITE RESOURCES, INC. AND THE OWNER. THE RECORD MAY BE A LEGIBLE HAND-WRITTEN FIELD SKETCH.
- EXISTING AND PROPOSED GAS LINES, ELECTRIC LINES, TELEPHONE LINES, COMMUNICATION LINES AND OTHER UTILITIES: EXISTING AND PROPOSED GAS LINES, STEAM LINES, ELECTRIC LINES, TELEPHONE LINES, COMMUNICATION DUCTS AND OTHER SUCH UTILITIES ARE NOT PART OF THE SCOPE OF WORK SHOWN ON THESE SITE PLANS AND SITE RESOURCES, INC. HAS NO RESPONSIBILITY FOR DESIGN, SPECIFICATION OR INSTALLATION OF SAID UTILITIES. TO THE EXTENT THAT SOME OR ALL OF SUCH UTILITIES (WHETHER EXISTING OR PROPOSED) APPEAR ON THE SITE DRAWINGS, THE CORRECTNESS AND COMPLETENESS OF THE INFORMATION SHOWING THESE UTILITIES IS NOT GUARANTEED.
- UTILITIES TO REMAIN OPERATIONAL; ADJUSTMENT FOR FINAL GRADE: ALL EXISTING UTILITIES SHALL BE RETAINED UNLESS MARKED OTHERWISE. EXISTING UTILITIES NOT TO BE REMOVED ARE TO REMAIN OPERATIONAL AT ALL TIMES. EXISTING UTILITIES TO BE REPLACED OR RELOCATED SHALL REMAIN IN SERVICE UNTIL REPLACED OR RELOCATED UTILITIES ARE OPERATIONAL. ALL EXISTING UTILITY APPURTENANCES SHALL BE ADJUSTED FOR FINAL GRADE.
- STANDARD CONSTRUCTION SPECIFICATIONS AND DETAILS: UNLESS OTHERWISE NOTED OR DETAILED ON THE DRAWINGS, ALL CONSTRUCTION SHALL FOLLOW THE LATEST ST. MARY'S COUNTY STANDARD SPECIFICATIONS AND DETAILS FOR CONSTRUCTION AS AMENDED TO DATE.
- SEDIMENT CONTROL: THE CONTRACTOR SHALL COORDINATE INSTALLATION OF ALL UTILITIES TO AVOID CONSTRUCTION PROBLEMS/CONFLICTS WITH SEDIMENT AND EROSION CONTROL MEASURES. ANY DISTURBANCE TO SEDIMENT AND EROSION CONTROL MEASURES SHALL BE REPAIRED AT THE END OF EACH WORKING DAY. CONTRACTOR SHALL, WITHOUT EXTRA COST TO THE PROJECT, REPAIR AND MAINTAIN EXISTING SEDIMENT CONTROL DEVICES UNTIL ALL AREAS WITHIN LIMITS OF CONSTRUCTION ARE STABILIZED. WITH THE APPROVAL OF SEDIMENT CONTROL INSPECTOR, ALL SEDIMENT CONTROL DEVICES SHALL BE REMOVED AND AREAS RESTORED AND STABILIZED. ALL SEDIMENT CONTROL MEASURES REFERRED TO ON THESE PLANS SHALL BE IN ACCORDANCE WITH THE PUBLICATION ENTITLED 2011 MARYLAND STANDARDS AND SPECIFICATIONS FOR SOIL EROSION AND SEDIMENT CONTROL.
- DISTURBED AREAS: ALL AREAS DISTURBED BY THE CONTRACTOR DURING OR PRIOR TO CONSTRUCTION, NOT DESIGNATED TO RECEIVE PAVING, MULCH OR SOLID SOD SHALL BE FINE GRADED, SEEDED AND MULCHED IN ACCORDANCE WITH THE PERMANENT SEEDING NOTES AND SPECIFICATIONS SHOWN ON THE SEDIMENT CONTROL DRAWINGS.
- REPAIR AND REPLACEMENT OF DAMAGE CAUSED BY CONTRACTOR AND SUBCONTRACTORS: IN THE EVENT THAT THE CONTRACTOR OR ANY OF HIS SUBCONTRACTORS DAMAGE ANY EXISTING CURB, GUTTER, PAVING, UTILITIES, SIDEWALKS, TREES, SHRUBS, LAWNS, OR ANY OTHER EXISTING CONDITIONS (NOT INDICATED TO BE DEMOLISHED), OR ANY NEWLY INSTALLED PROPOSED IMPROVEMENT, THE GENERAL CONTRACTOR SHALL REPAIR AND REPLACE SAID DAMAGE TO OWNER'S SATISFACTION, AT GENERAL CONTRACTOR'S SOLE COST AND EXPENSE.
- BENCHMARKS: SEE EXISTING CONDITIONS & DEMOLITION PLAN.
- ELEVATION AND LABELING: ALL SPOT GRADE ELEVATIONS IN ROADWAYS AND PARKING LOTS ARE FOR BOTTOM OF CURB UNLESS OTHERWISE NOTED. ELEVATIONS ON HARD SURFACES (ROADS, WALKS, WALLS, STEPS, MANHOLES, INLETS, ETC.) ARE LABELED TO THE HUNDREDTH OF A FOOT (E.G. 245.45). ELEVATIONS ON PROPOSED LAWN AND PLANTING AREAS ARE LABELED TO THE TENTH OF A FOOT (E.G. 245.5).
- DIMENSIONS: UNLESS OTHERWISE NOTED ON THE DRAWING, ALL DIMENSIONS SHOWN ON THE SITE DRAWINGS FOLLOW THESE CONVENTIONS:
 - DIMENSIONS TO A BUILDING OR RETAINING WALL ARE TO THE FACE OF THE WALL;
 - DIMENSIONS TO A CURB ARE TO THE FACE (NOT THE BACK) OF THE CURB;
 - DIMENSIONS TO A FENCE ARE TO THE CENTERLINE OF THE FENCE;
 - DIMENSIONS FOR SIDEWALKS ABUTTING A CURB ARE FROM THE FACE OF CURB TO THE BACK EDGE OF THE WALK;
 - DIMENSIONS FOR OTHER SIDEWALKS OR OPEN PAVING SECTIONS ARE MEASURED TO THE EDGE OF PAVING;
 - DIMENSIONS TO A MANHOLE, INLET, CLEANOUT, PIPE BEND, VALVE, FIRE HYDRANT OR OTHER UTILITY APPURTENANCE ARE TO THE CENTER OF THE STRUCTURE;
 - DIMENSIONS FOR STEPS ARE TO THE OUTER EDGE OF THE STAIRCASE AND THE NOSE OF THE TOP OR BOTTOM STEP;
 - LAYOUT OF SEDIMENT CONTROL MEASURES AND PLANT MATERIAL SHALL BE SCALED.

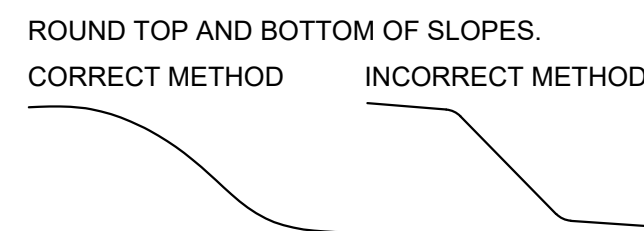

DRAWING INDEX

DRAWING NO.	DRAWING NAME
C001	Civil Notes
C101	Existing Conditions & Demolition Plan
C111	Proposed Site Plan
C201	Site Details
C202	Site Details
C203	Site Details
E0.1	Electrical Abbreviations, Symbols, General Notes
E1.1	Site Lighting Plan
E2.1	Site Lighting Calculation
ESC101	Erosion & Sediment Control Overlay Plan
ESC201	Erosion & Sediment Control Notes
ESC202	Erosion & Sediment Control Notes
ESC203	Erosion & Sediment Control Details
L101	Landscape Plan

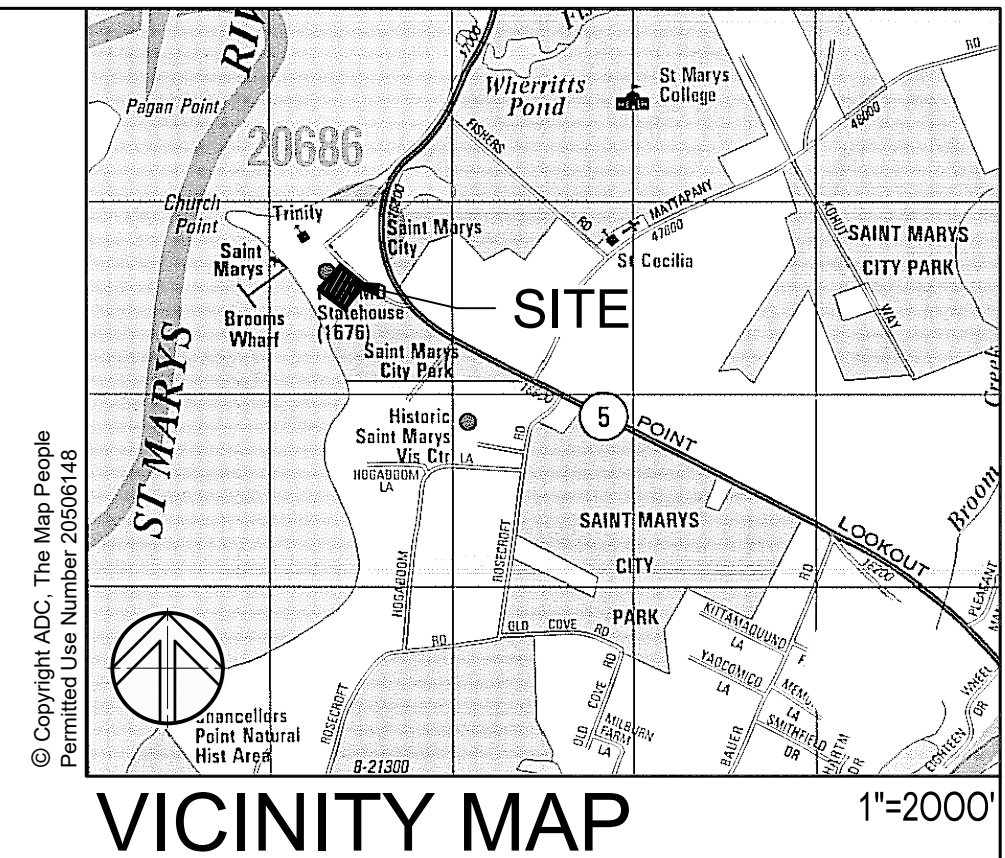

HISTORIC ST. MARY'S CITY & ST. MARY'S COLLEGE OF MARYLAND

MARYLAND HERITAGE INTERPRETIVE CENTER PARKING LOT

ST. MARY'S CITY, MD

PROFESSIONAL CERTIFICATION
I HEREBY CERTIFY THAT THESE DOCUMENTS WERE PREPARED OR APPROVED BY ME, AND THAT I AM A DULY LICENSED PROFESSIONAL ENGINEER UNDER THE LAWS OF THE STATE OF MARYLAND. LICENSE NO. 42977. EXPIRATION DATE: 06/07/2023.

REVISIONS



#	DATE	DESCRIPTION

DRAWN BY: ZJR CHECKED BY: PCS
DATE: 12/09/2022 PROJECT #: 08038
SCALE: AS SHOWN
DRAWING NAME:
CIVIL NOTES

DRAWING NO.:
C001

© SITE RESOURCES, INC. Z:\08108038-St. Marys College ArneAunde\HalDwg\WHIC Pkg Lot\C001 Civil Notes.dwg-C001 Nov_30_2022 04:02pm zjr

© SITE RESOURCES, INC. Z:\08\08038-St. Marys College\Amdel\Hal\Draw\WHIC Pkg_Lot\C101 Existing Conditions Plan.dwg-C101 Nov 30, 2022 04:03pm zjr

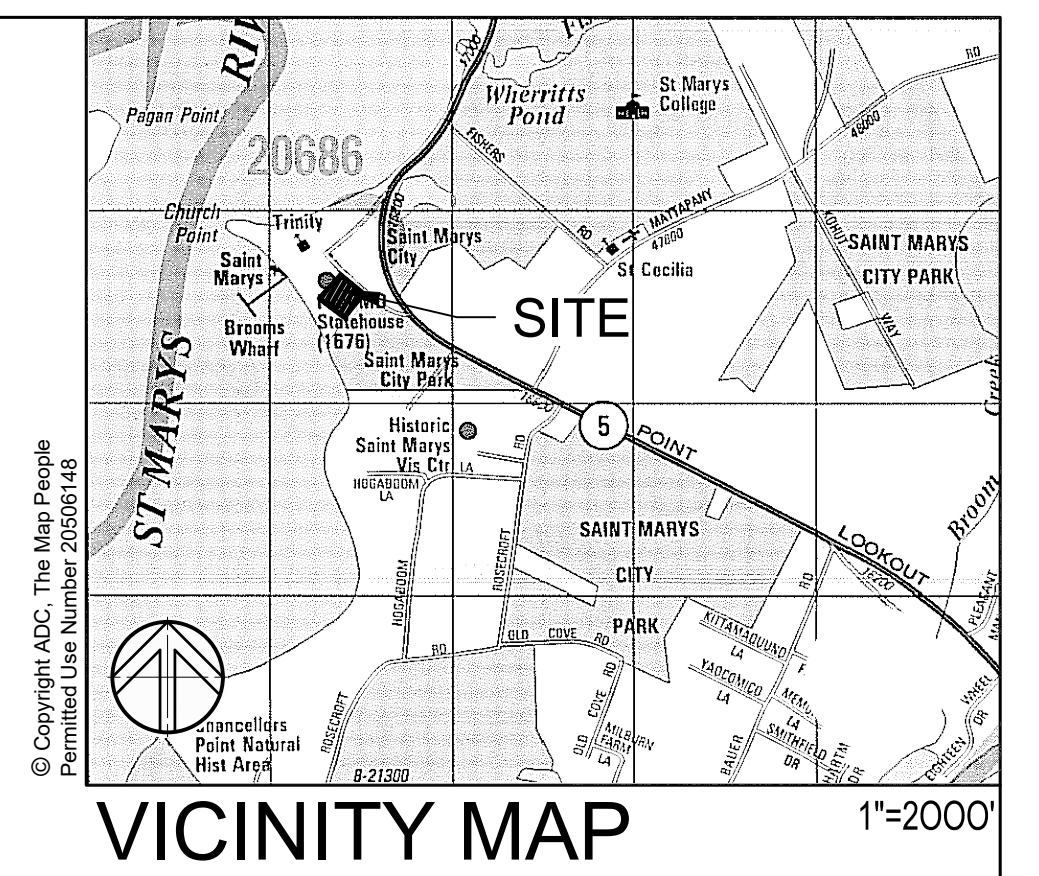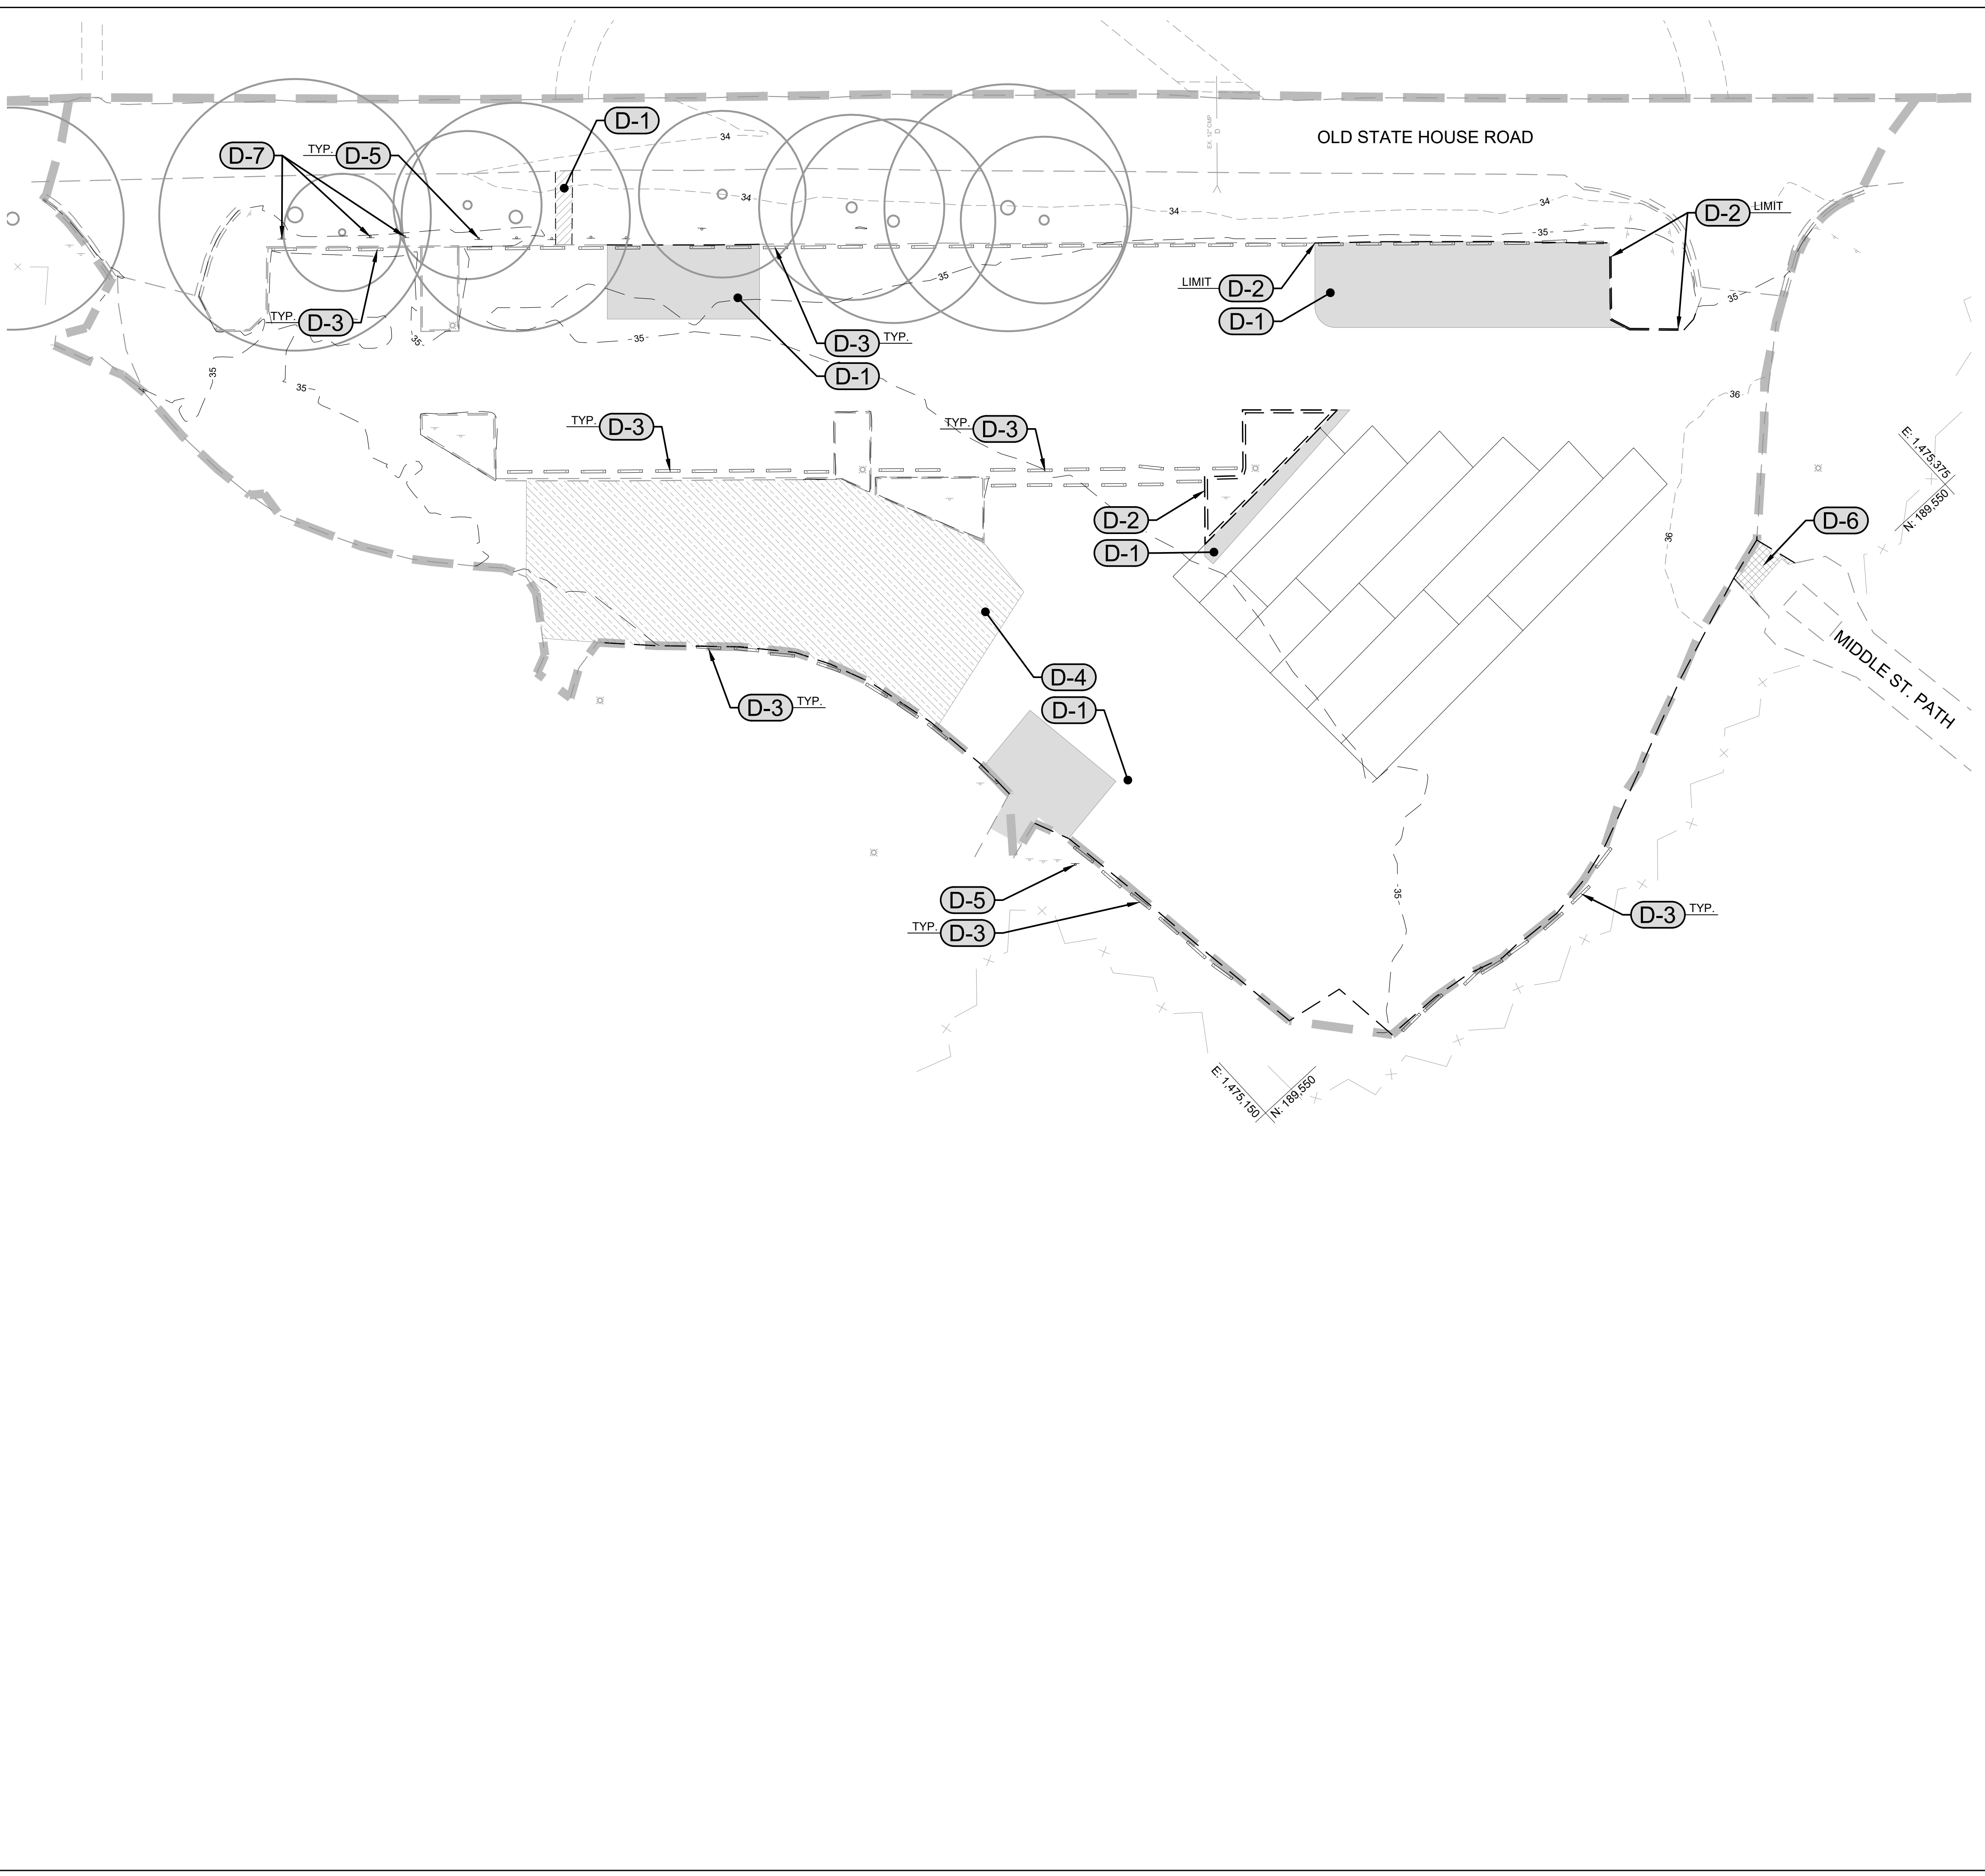

LEGEND


	EXISTING WALK TO REMAIN
	EXISTING WALK TO BE REMOVED
	EXISTING ROAD TO REMAIN
	EXISTING CURB TO REMAIN
	EXISTING CURB TO BE REMOVED
	EXISTING VEHICULAR PAVERS TO BE REMOVED
	EXISTING BRICK PAVERS TO BE REMOVED
	EXISTING VEHICULAR PAVERS MAINTENANCE
	EXISTING GRAVEL WALKWAY TO BE REMOVED
	EXISTING FENCE TO REMAIN
	EXISTING SIGN TO REMAIN
	EXISTING SIGN TO BE REMOVED
	EXISTING WHEELSTOP TO REMAIN
	EXISTING WHEELSTOP TO BE REMOVED
	EXISTING TREES TO REMAIN
	EXISTING STORM DRAIN TO REMAIN
	EXISTING CONTOURS

- DEMOLITION NOTES**
- (D-1)** REMOVE EXISTING PAVERS AND BASE MATERIAL TO LIMITS SHOWN
 - (D-2)** SAW CUT AS APPROPRIATE AND REMOVE EXISTING WOODEN CURB TO LIMITS SHOWN
 - (D-3)** SALVAGE AND STORE EXISTING CONCRETE WHEEL STOP FOR REUSE, WHERE FEASIBLE
 - (D-4)** REMOVE EXISTING PAVERS. CONTRACTOR SHALL NOT DISTURB EXISTING BASE MATERIAL AND SUBGRADE
 - (D-5)** SALVAGE EXISTING SIGN, POST, AND ASSOCIATED FOOTING
 - (D-6)** REMOVE EXISTING GRAVEL WALKWAY TO LIMITS SHOWN
 - (D-7)** REMOVE EXISTING SIGNAGE, POST, AND ASSOCIATED FOOTING.

SURVEY CONTROL NOTES
 BEARINGS SHOWN HEREON ARE BASED ON THE MARYLAND STATE PLANE COORDINATE SYSTEM- NAD 83(1991) AND REFERENCED FROM THE FOLLOWING

901 N. 235.131.4904 E. 1,446,885.2621 ELEV. 105.34 REBAR AND CAP COMBINED FACTOR: NOT AVAILABLE

903 N. 234.769.8112 E. 1,447,079.9041 ELEV. 131.67 REBAR AND CAP COMBINED FACTOR: NOT AVAILABLE

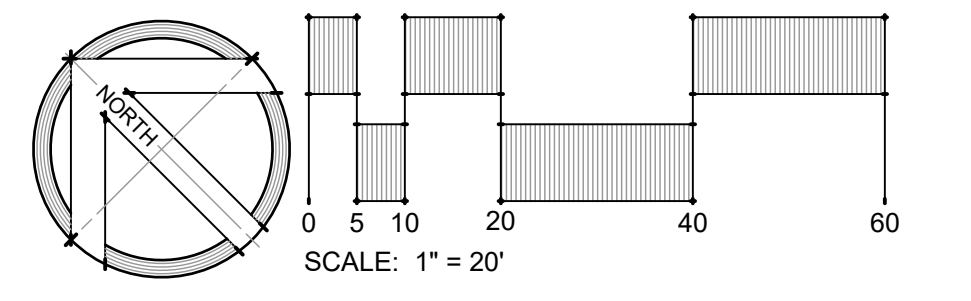

HISTORIC ST. MARY'S CITY & ST. MARY'S COLLEGE OF MARYLAND

MARYLAND HERITAGE INTERPRETIVE CENTER PARKING LOT

ST. MARY'S CITY, MD

PROFESSIONAL CERTIFICATION
 I HEREBY CERTIFY THAT THESE DOCUMENTS WERE PREPARED OR APPROVED BY ME, AND THAT I AM A DULY LICENSED PROFESSIONAL ENGINEER UNDER THE LAWS OF THE STATE OF MARYLAND. LICENSE NO. 42977. EXPIRATION DATE: 06/07/2023.

REVISIONS

#	DATE	DESCRIPTION


DRAWN BY: ZJR CHECKED BY: PCS
 DATE: 12/09/2022 PROJECT #: 08038
 SCALE: AS SHOWN
 DRAWING NAME:
EXISTING CONDITIONS & DEMOLITION PLAN

DRAWING NO.: **C101**

HISTORIC ST. MARY'S CITY & ST. MARY'S COLLEGE OF MARYLAND

MARYLAND HERITAGE INTERPRETIVE CENTER PARKING LOT

ST. MARY'S CITY, MD

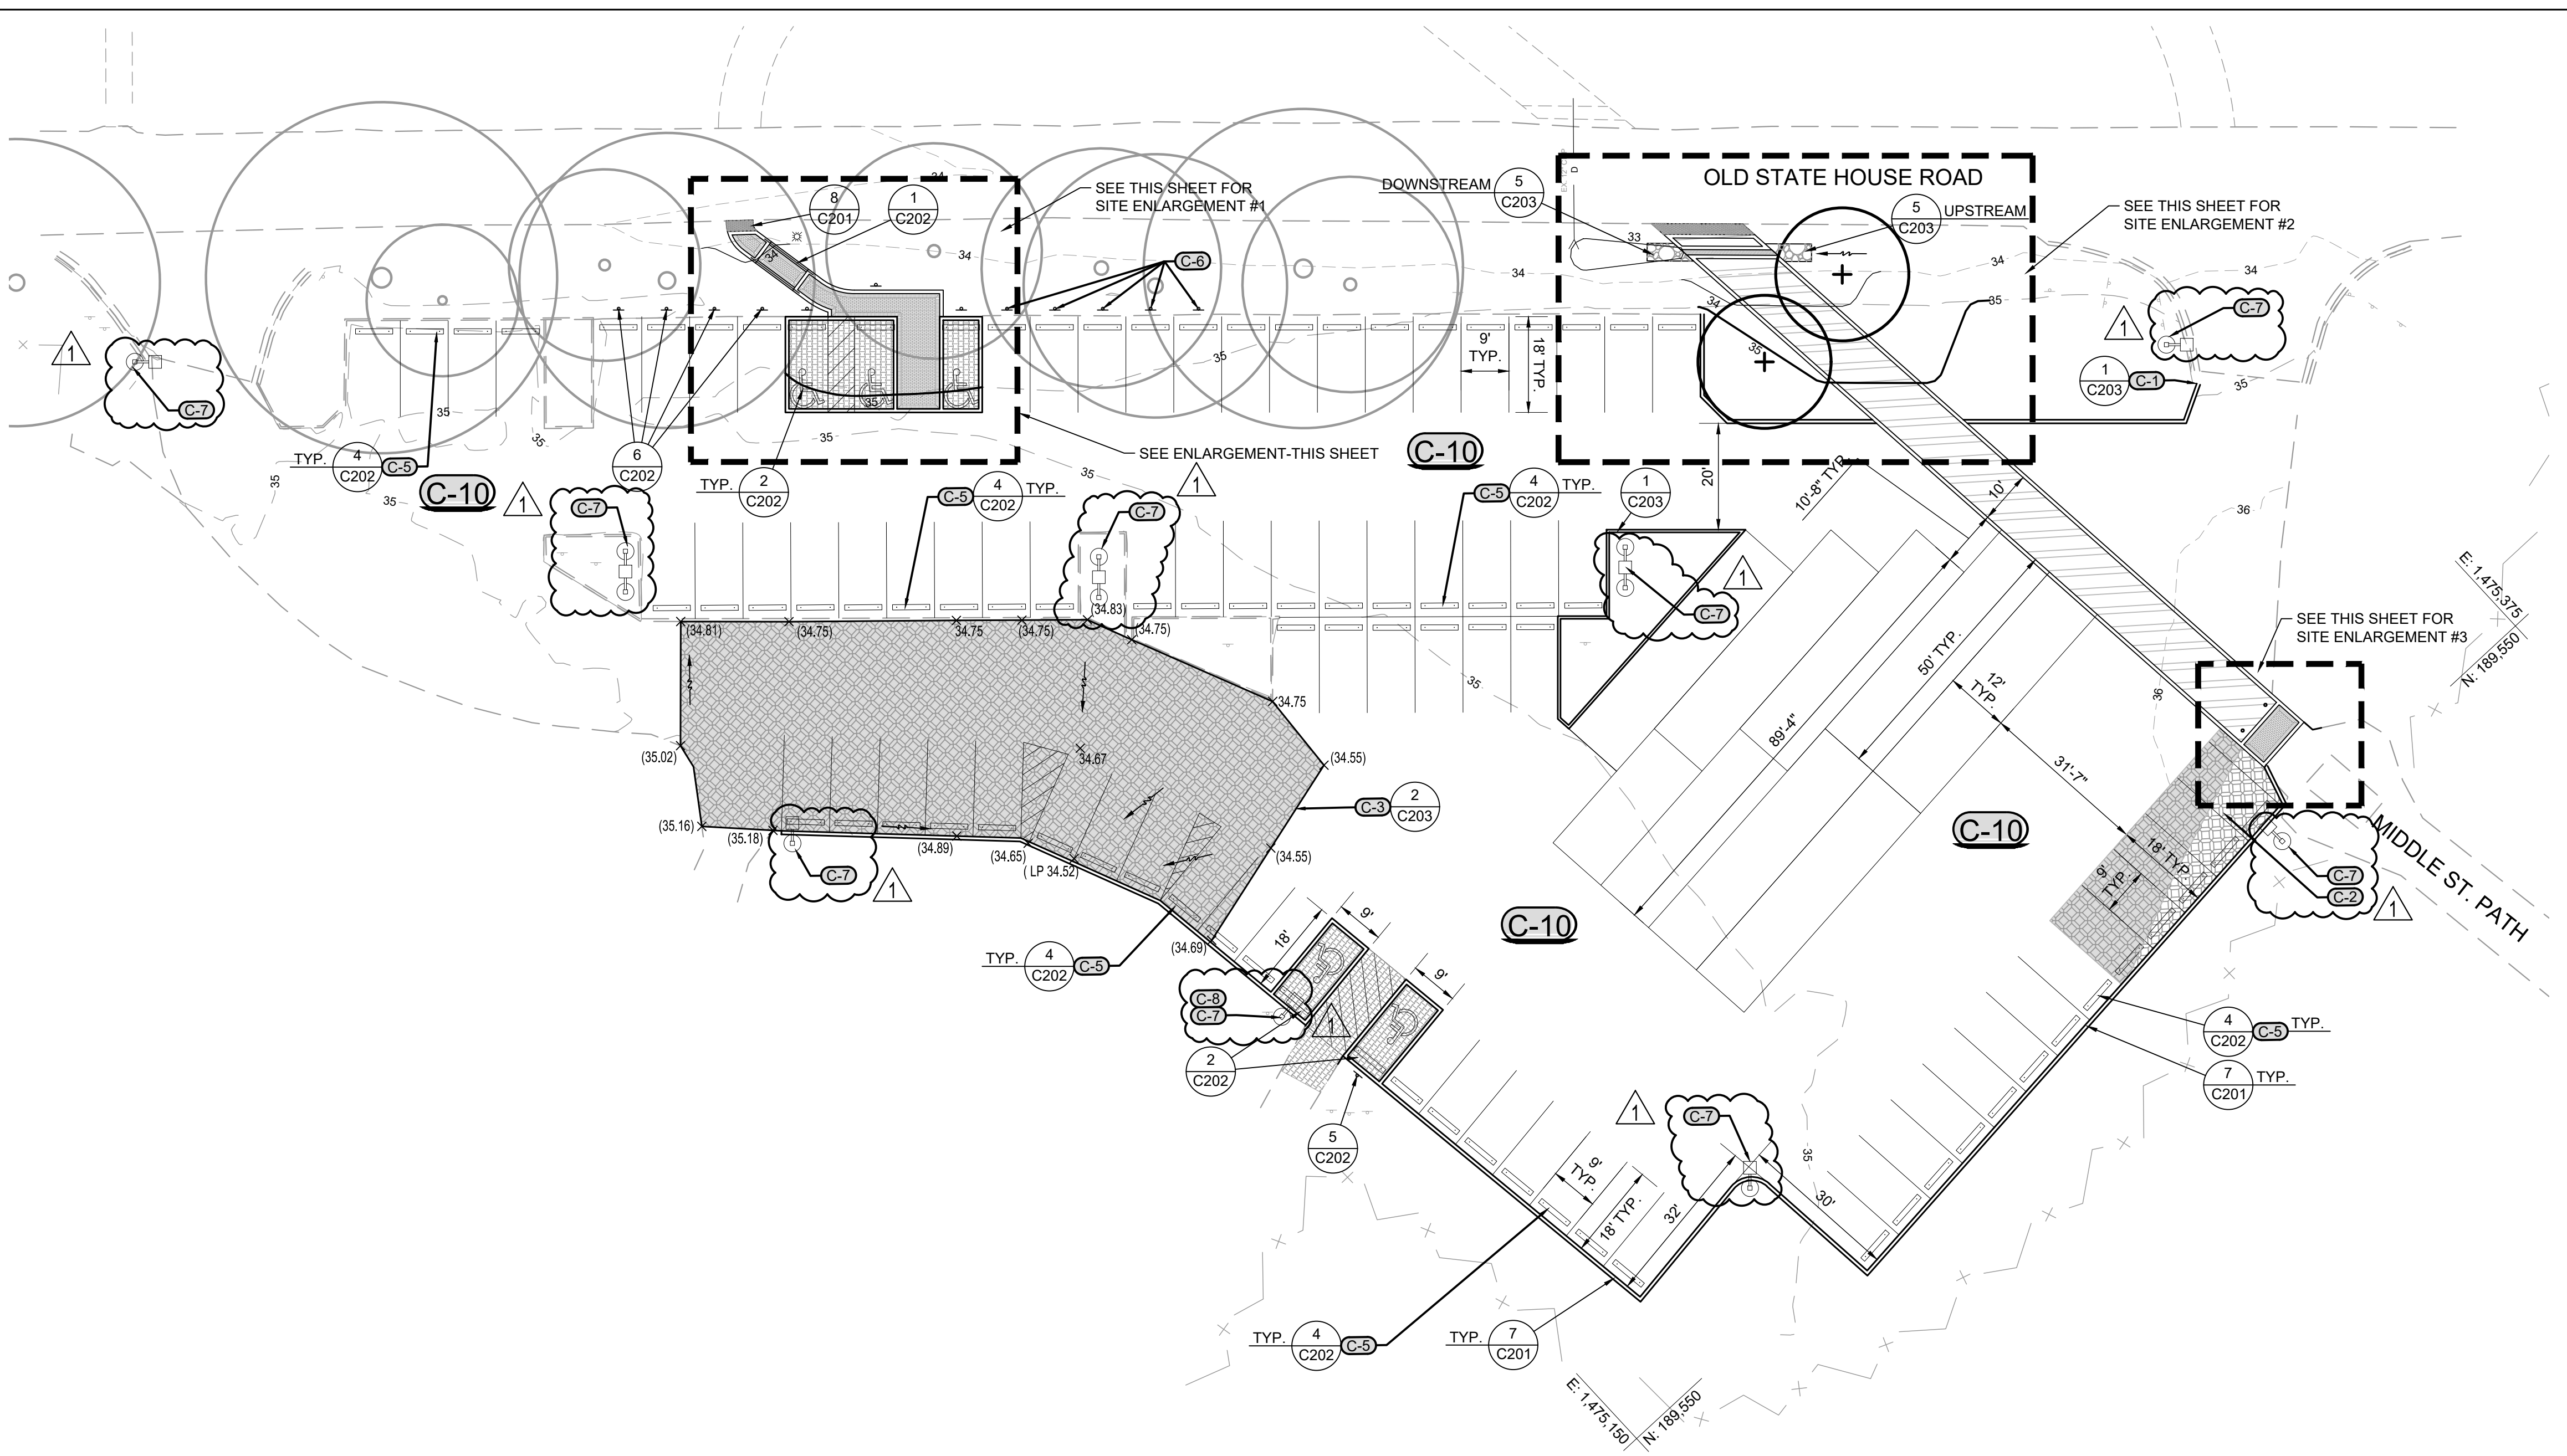

LEGEND

- EXISTING WALK
- EXISTING ROAD
- EXISTING CURB
- EXISTING FENCE
- ⊗ EXISTING LIGHTING
- ⊗ EXISTING SIGN
- D- EX. SD
- D- EXISTING STORM DRAIN
- EXISTING CONTOURS
- EXISTING TREES
- 3 C201 PROPOSED OLDE HANDOVER PEST BRICK PAVER
- 4 C201 PROPOSED VEHICLE RATED PERMEABLE PAVER
- 2 C203 PROPOSED TURFSTONE PERMEABLE PAVERS
- 3 C203 EXISTING PERMEABLE PAVER SUB-BASE REPAIR
- 5 C201 PROPOSED PERMA DRIVE
- PROPOSED EDGE OF PAVING
- PROPOSED CURB
- 1 PROPOSED RIPRAP
- ⊗ PROPOSED SIGN
- ⊗ ⊗ ⊗ PROPOSED LIGHTING
- 348 350 PROPOSED CONTOURS
- ⊗ (220.8) EXISTING SPOT ELEVATIONS
- ⊗ 220.8 PROPOSED SPOT ELEVATIONS

GENERAL SHEET NOTE:
 THERE SHALL BE NO SUBGRADE DISTURBANCE OUTSIDE OF THE LIMIT OF DISTURBANCE.

- CONSTRUCTION NOTES:**
- C-1** PROPOSED REPLACEMENT & REALIGNMENT OF WOOD CURB
 - C-2** PROPOSED FULL DEPTH EXPANSION OF EXISTING PAVERS
 - C-3** ADJUST STONE BASE AND PAVER WITHIN THIS AREA AS REQUIRED TO ALLEVIATE POOLING
 - C-4** PROPOSED TRENCH DRAIN & CHEEKWALL SEE 6/C203 FOR BASIS OF DESIGN
 - C-5** REINSTALL SALVAGED CONCRETE WHEEL STOPS, WHERE FEASIBLE
 - C-6** REINSTALL SALVAGED STAFF SIGNAGE OWNER'S REPRESENTATIVE SHALL APPROVE FINAL LOCATION
 - C-7** PROPOSED LIGHT POLE AND BASE SEE ELECTRICAL PLANS FOR DETAILS
 - C-8** MOUNT HANDICAP PARKING SIGNAGE TO LIGHT POLE SEE 5/C202 FOR HANDICAP SIGNAGE CONTRACTOR SHALL PROVIDE MOUNTING HARDWARE
 - C-9** PROPOSED HISTORIC LIGHT POST (ADD-ALTERNATE) SEE ELECTRICAL PLANS FOR DETAILS

C-10 IDENTIFY AND REPAIR THE THE PARKING LOT TO ENSURE THE LOT IS SAFE AND FREE FROM ANY TRIP HAZARDS. THE ENTIRE PARKING LOT SHALL DRAIN EFFECTIVELY AND BE FREE OF ANY POOLING.


PROFESSIONAL CERTIFICATION
 I HEREBY CERTIFY THAT THESE DOCUMENTS WERE PREPARED OR APPROVED BY ME, AND THAT I AM A FULLY LICENSED PROFESSIONAL ENGINEER UNDER THE LAWS OF THE STATE OF MARYLAND, LICENSE NO. 42977, EXPIRATION DATE: 06/07/2023.

REVISIONS


#	DATE	DESCRIPTION
1	5/16/2023	ADDENDUM 1

DRAWN BY: ZJR CHECKED BY: PCS
 DATE: 05/16/2023 PROJECT #: 08038
 SCALE: AS SHOWN
 DRAWING NAME:
PROPOSED SITE PLAN


DRAWING NO.: **C111**

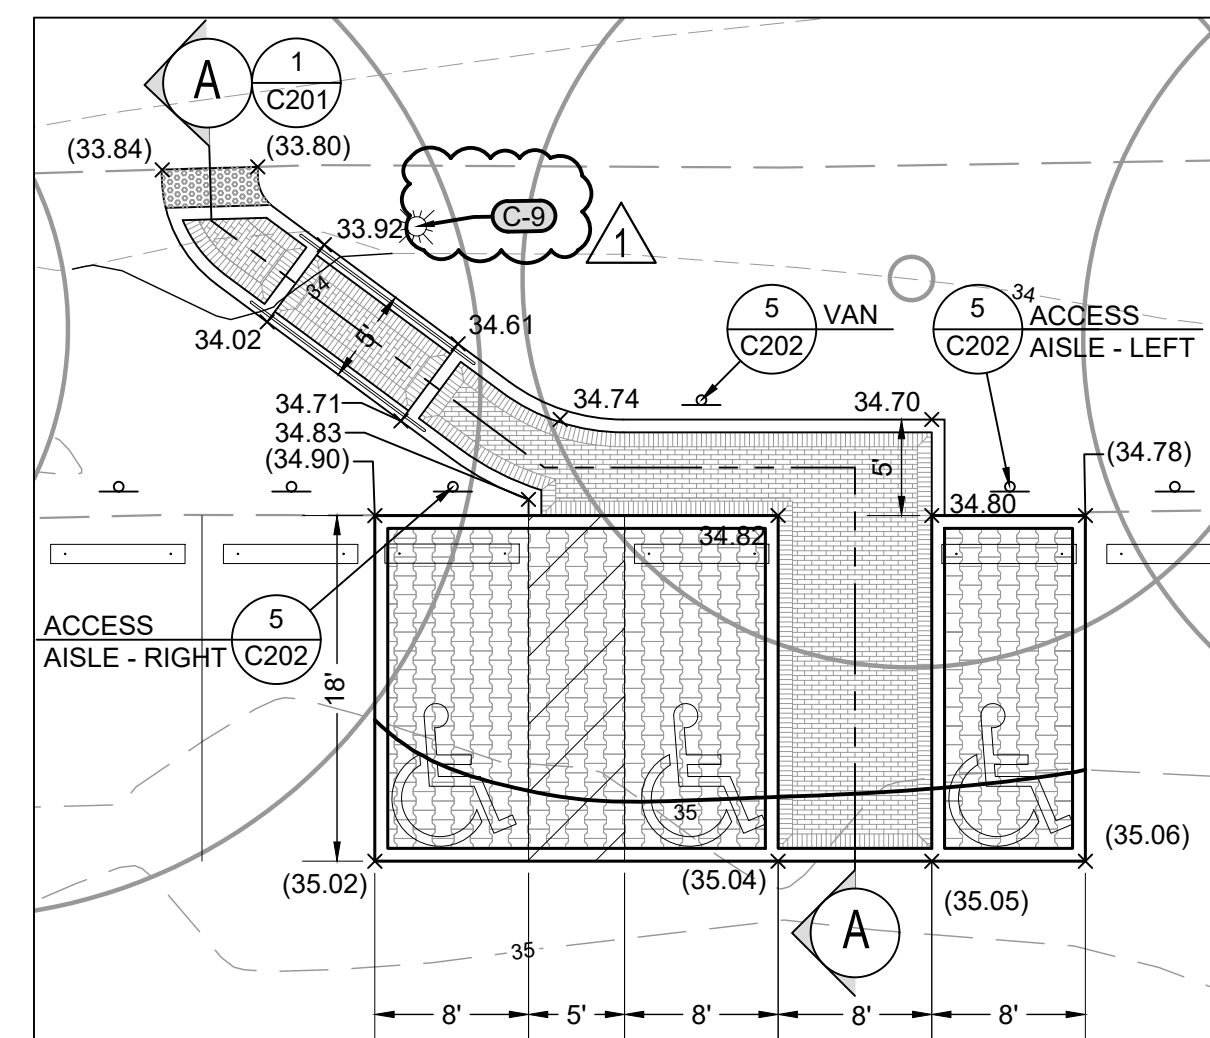


1 SITE ENLARGEMENT #1
 SCALE: 1" = 10'

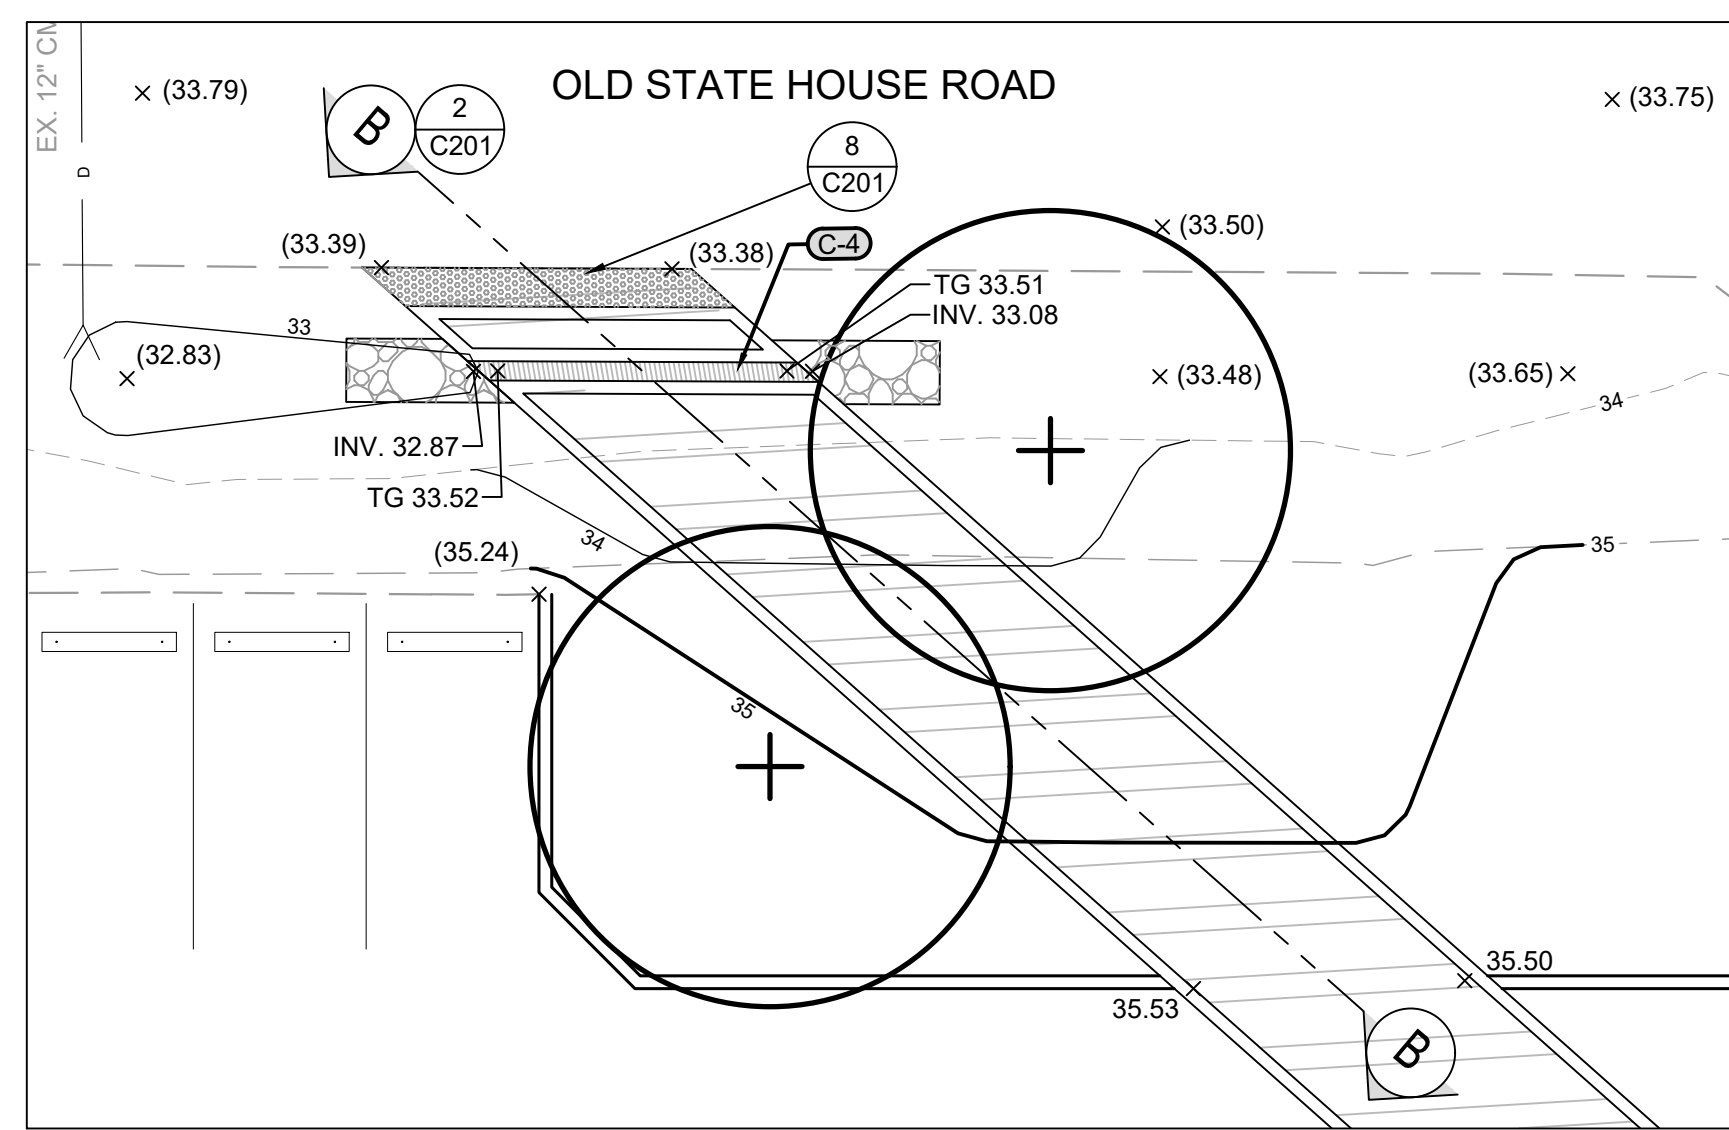

2 SITE ENLARGEMENT #2
 SCALE: 1" = 10'

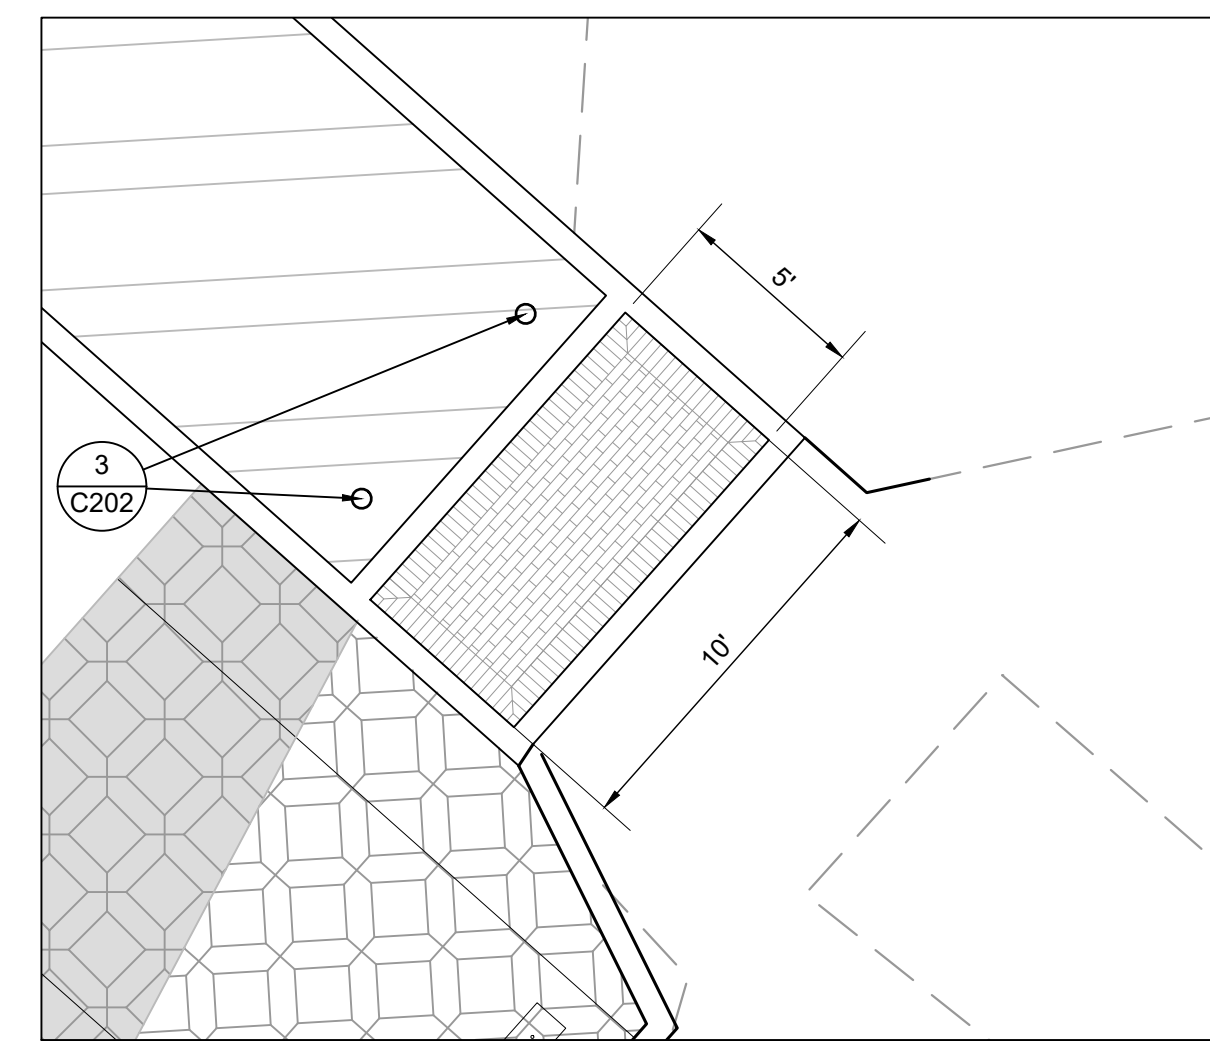

3 SITE ENLARGEMENT #3
 SCALE: 1" = 5'

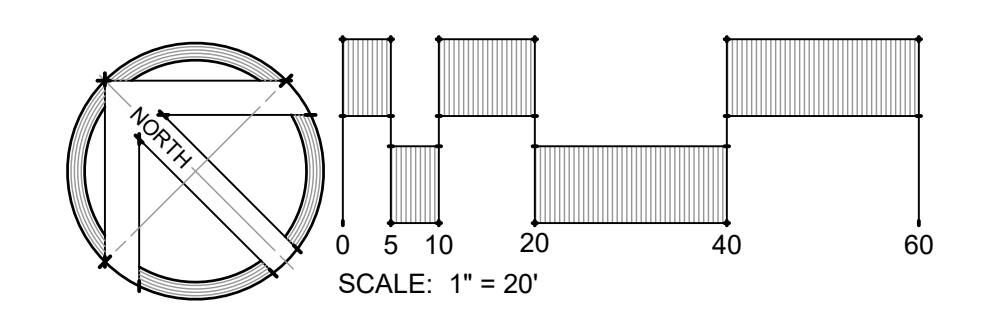


© SITE RESOURCES, INC. Z:\08038-St. Marys College-AnneArundel\HalDwyer\WHIC Pkg Lot\C111_Site Plan.dwg-C111_May 16, 2023 11:42am zjr


HISTORIC ST. MARY'S CITY & ST. MARY'S COLLEGE OF MARYLAND

MARYLAND HERITAGE INTERPRETIVE CENTER PARKING LOT


ST. MARY'S CITY, MD

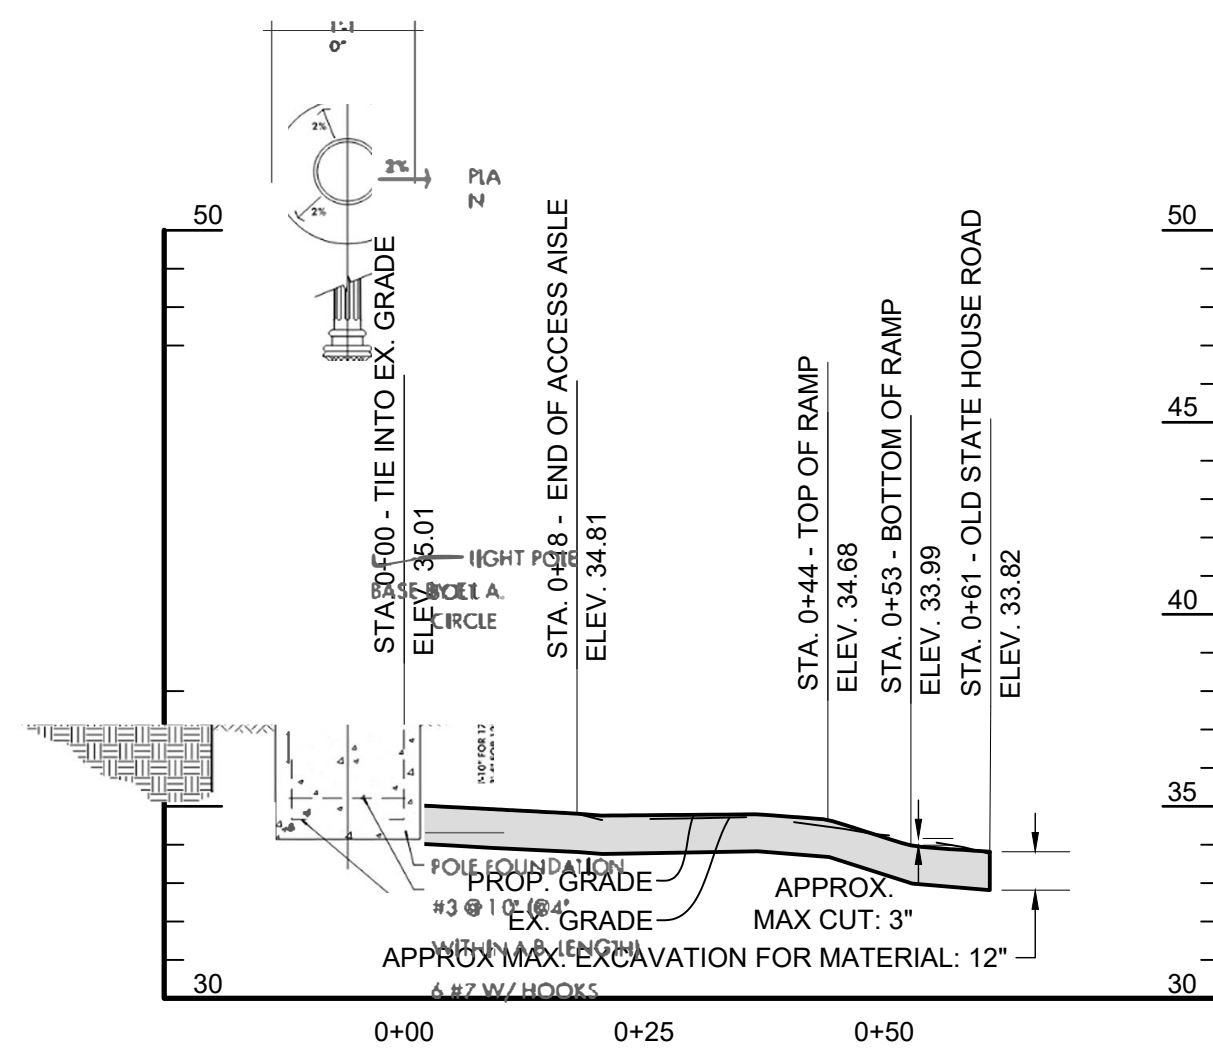

1 SECTION A-A ADA RAMP PROFILE
 SCALES: HORIZ. 1" = 20'
 VERT. 1" = 5'

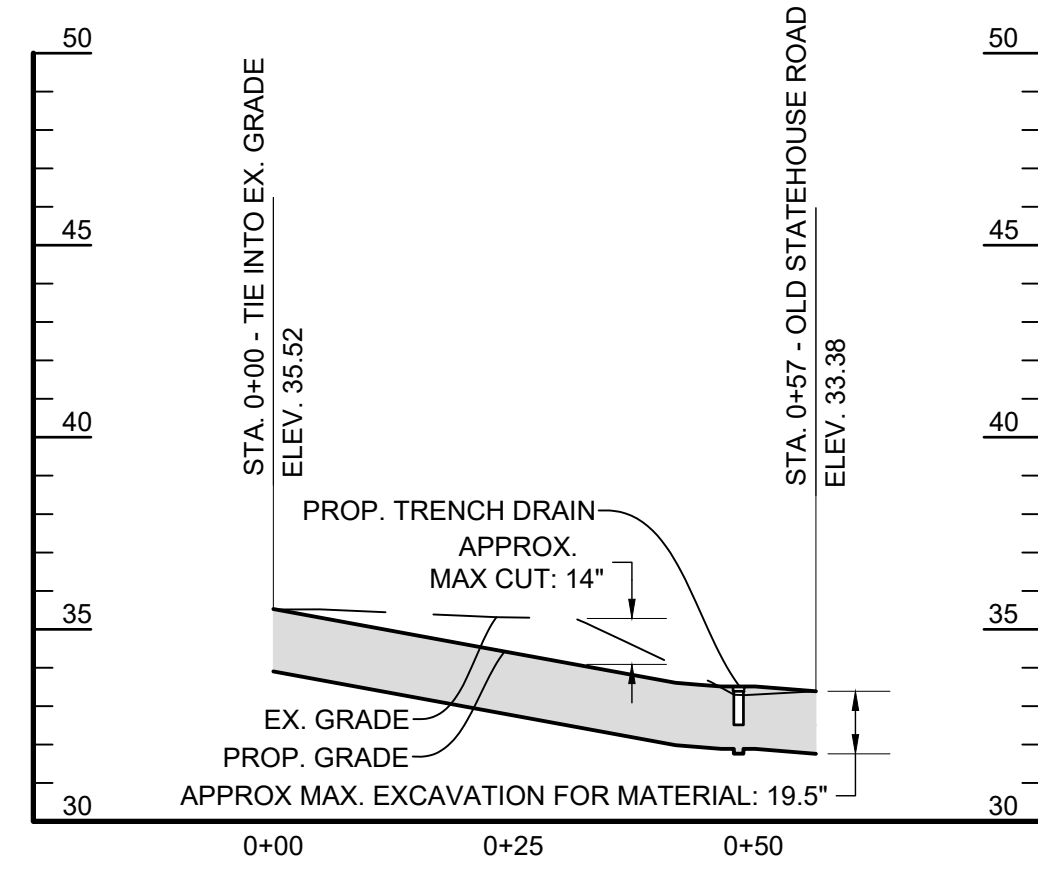


2 SECTION B-B PERMADRIE PROFILE
 SCALES: HORIZ. 1" = 20'
 VERT. 1" = 5'

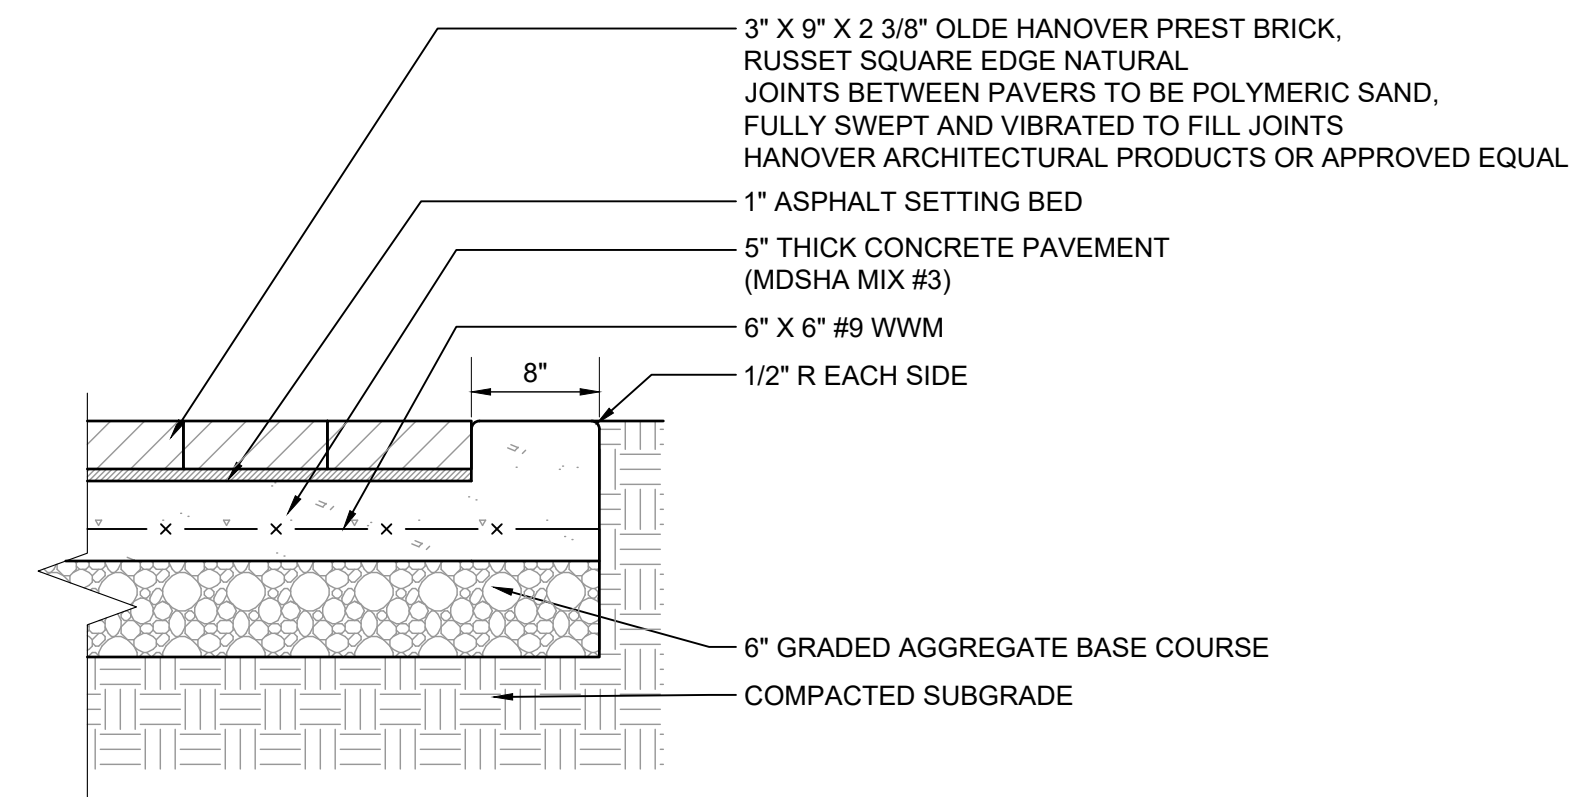


- NOTES:
- PAVERS SHALL BE FLUSH WITH SURROUNDING EXISTING PAVEMENT.
 - JOINT BETWEEN PAVERS AND ADJACENT TO EXISTING CONCRETE SHALL BE FILLED WITH POLYMERIC SAND. POLYMERIC SAND SHALL BE FULLY SWEEPED AND VIBRATED TO FILL JOINTS.
 - PROVIDE ISOLATION JOINTS WHERE POUR MEETS ALL PROPOSED VERTICAL CONDITIONS.

3 BRICK PAVERS
 1" = 1'-0"

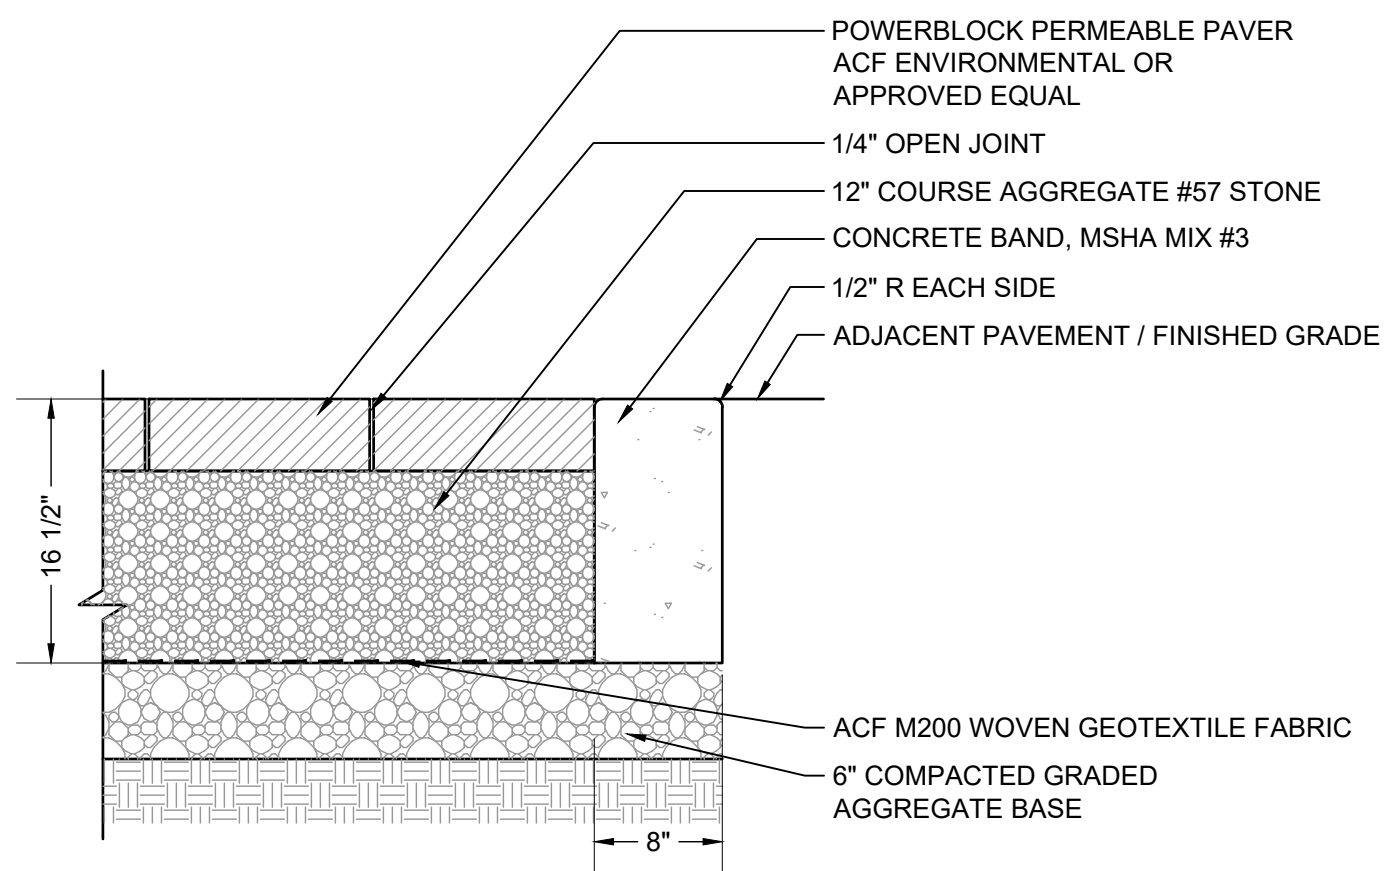


- NOTES:
- PAVER SHALL BE FLUSH WITH SURROUNDING EXISTING PAVERS.

4 POWERBLOCK PERMEABLE PAVER
 1" = 1'-0"

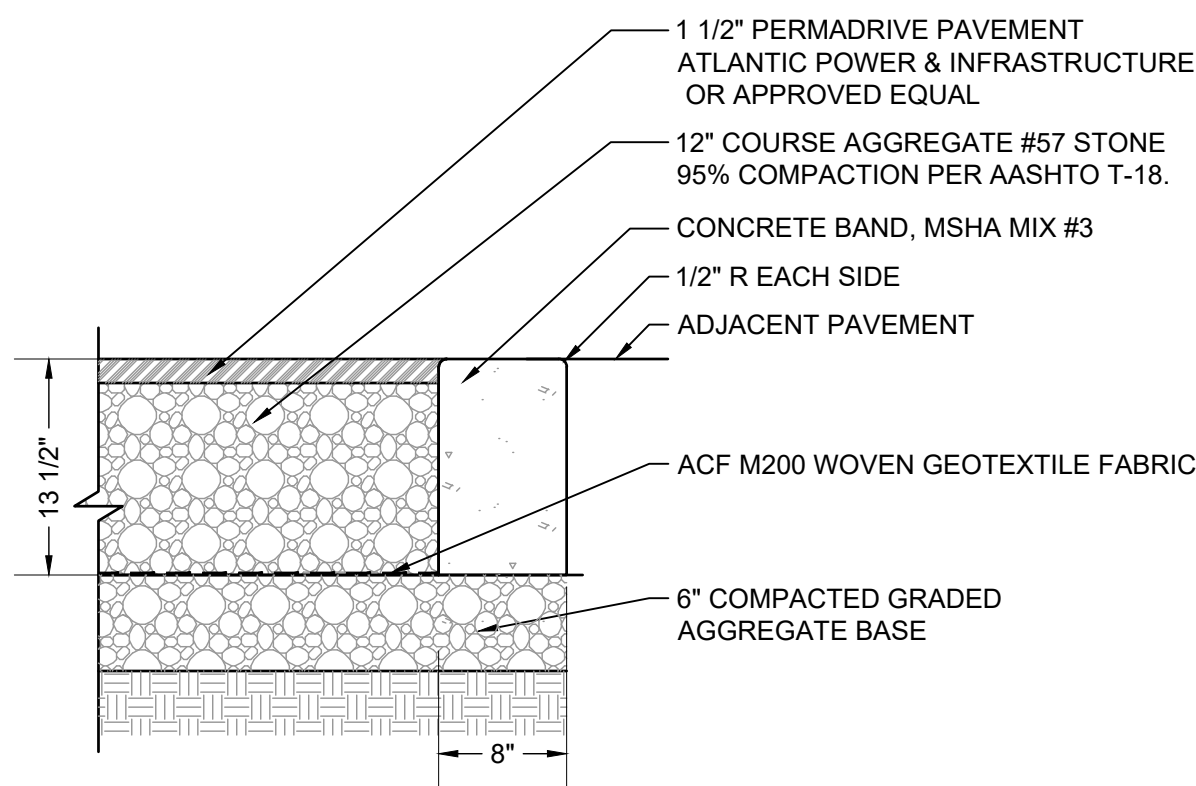


5 PERMADRIE PAVEMENT
 1" = 1'-0"

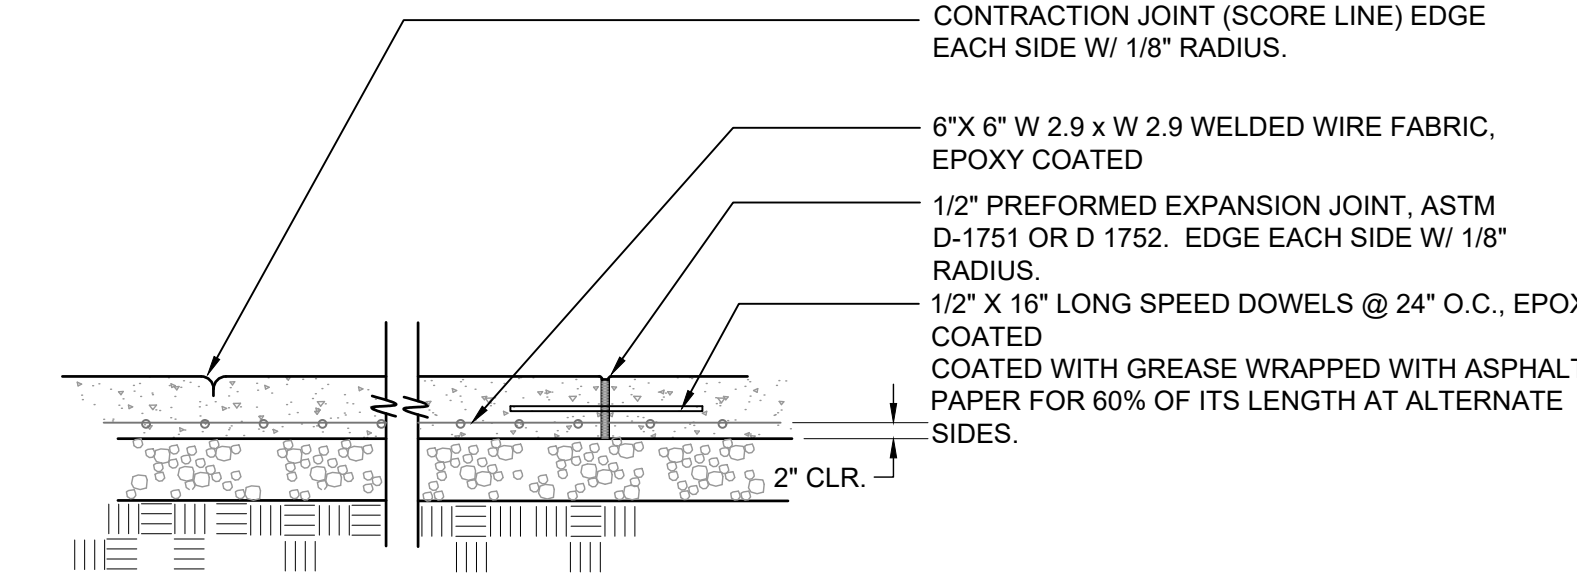


- NOTES:
- PLACE EXPANSION JOINTS NOT MORE THAN 20'-25' APART AND AT THE END OF EACH CONTIGUOUS POUR.
 - PLACE CONTRACTION JOINTS AT INTERVAL MATCHING WIDTH OF SIDEWALK BUT NOT MORE THAN 6' APART.
 - PROVIDE EXPANSION JOINTS WHERE POUR MEETS EXISTING CONCRETE PAVING OR CURB.
 - EXPANSION JOINTS TO BE RECESSED 1/4" BELOW SURFACE OF SIDEWALK.
 - WHEN SIDEWALK ABUTS EXISTING CONCRETE WALK, CORE DRILL AND INSTALL DOWELS PER DETAIL.
 - MATCH SCORE PATTERN OF ADJACENT SIDEWALK WHERE PRACTICAL.
 - UNLESS OTHERWISE SHOWN ON PLAN, CONTRACTOR TO SUBMIT LAYOUT OF PROPOSED CONTRACTION EXPANSION JOINTS FOR APPROVAL PRIOR TO POURING CONCRETE.


6 EXPANSION & CONTRACTION JOINTS
 1" = 1'-0"

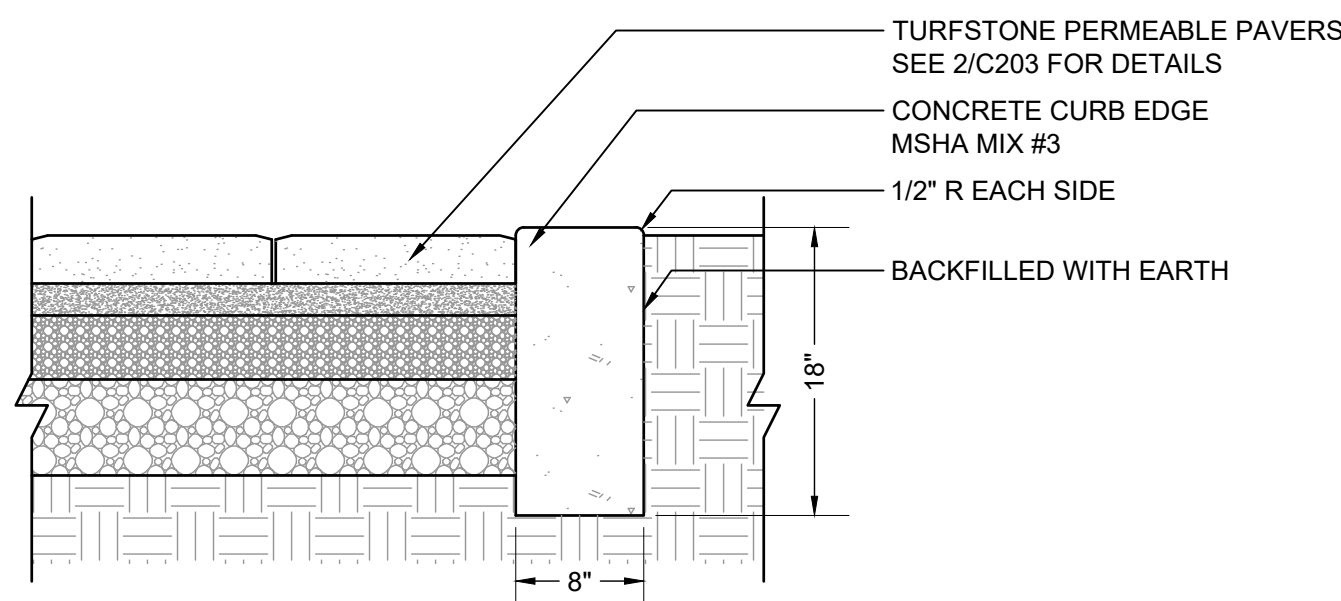

7 CONCRETE CURB EDGING
 1" = 1'-0"

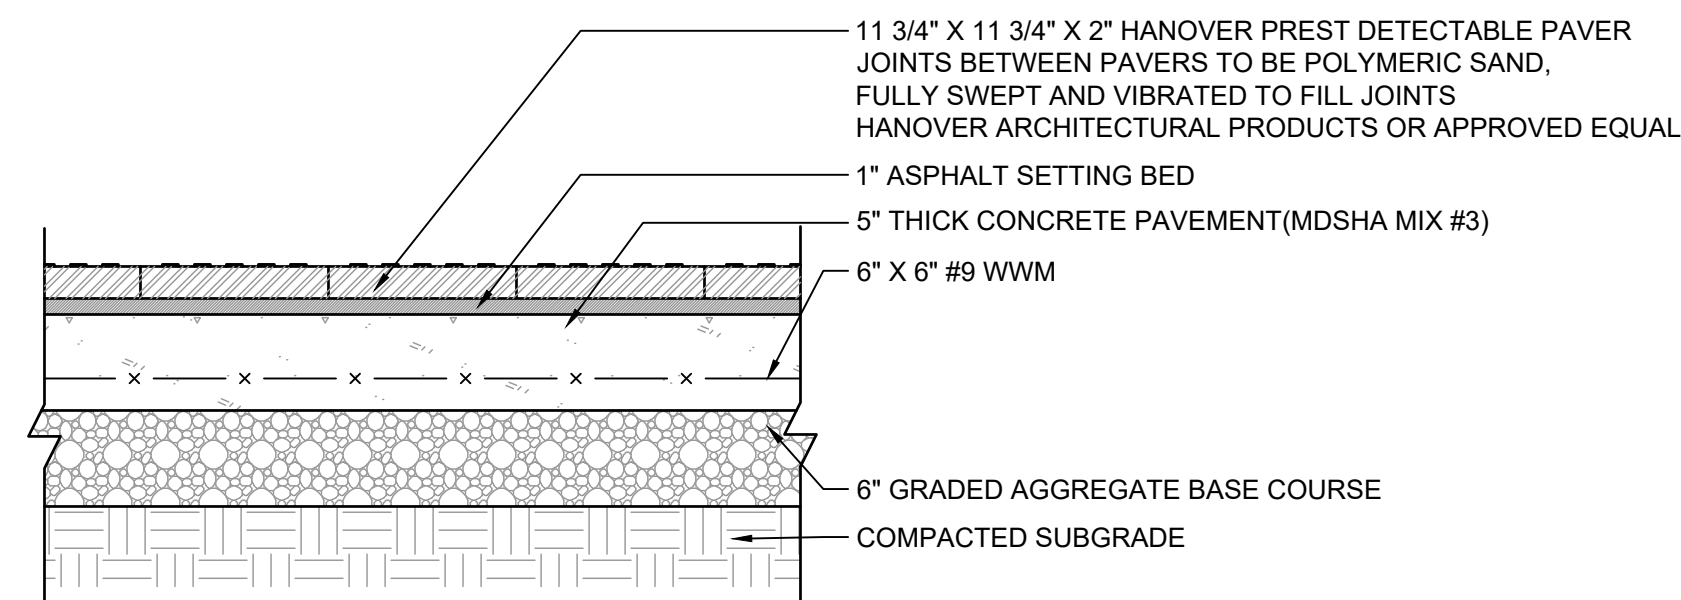

8 DETECTABLE WARNING PAVER
 1" = 1'-0"

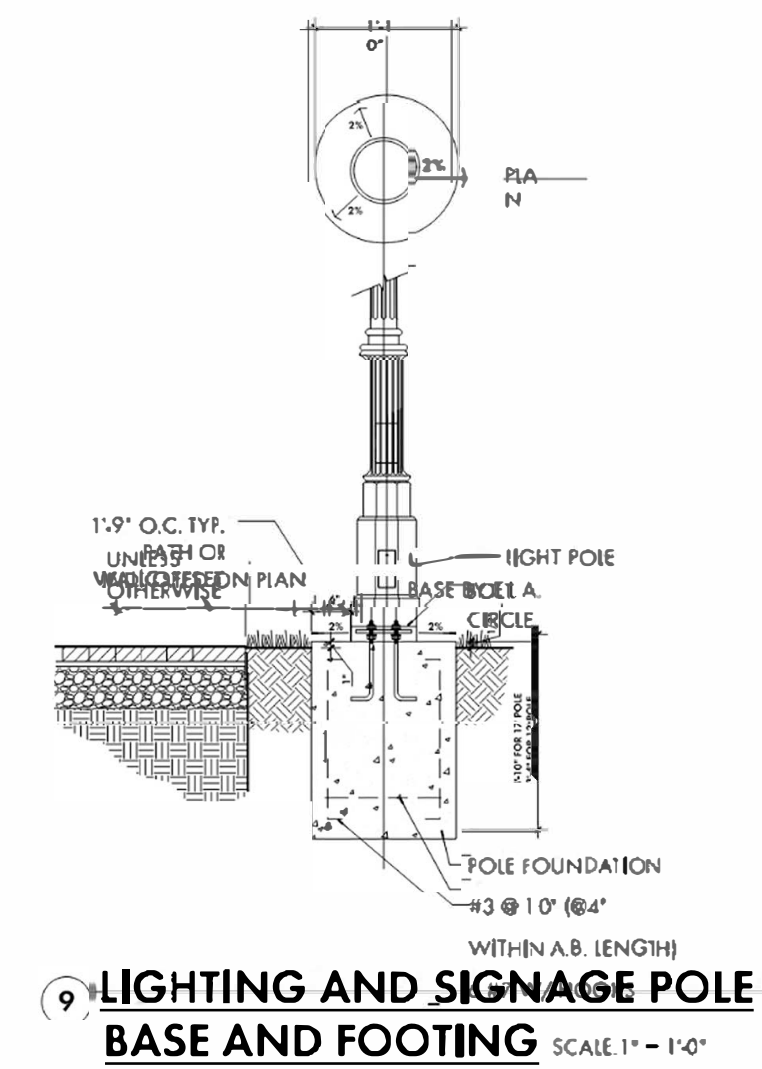

9 LIGHTING AND SIGNAGE POLE BASE AND FOOTING
 SCALE 1" = 1'-0"

PROFESSIONAL CERTIFICATION
 I HEREBY CERTIFY THAT THESE DOCUMENTS WERE PREPARED OR APPROVED BY ME, AND THAT I AM A DULY LICENSED PROFESSIONAL ENGINEER UNDER THE LAWS OF THE STATE OF MARYLAND, LICENSE NO. 42977.
 EXPIRATION DATE: 06/07/2023.

REVISIONS



#	DATE	DESCRIPTION
1	6/27/23	Lighting & Pole Base Update

DRAWN BY: ZJR CHECKED BY: PCS
 DATE: 12/09/2022 PROJECT #: 08038


SCALE: AS SHOWN
 DRAWING NAME:
SITE DETAILS

DRAWING NO.:

C201

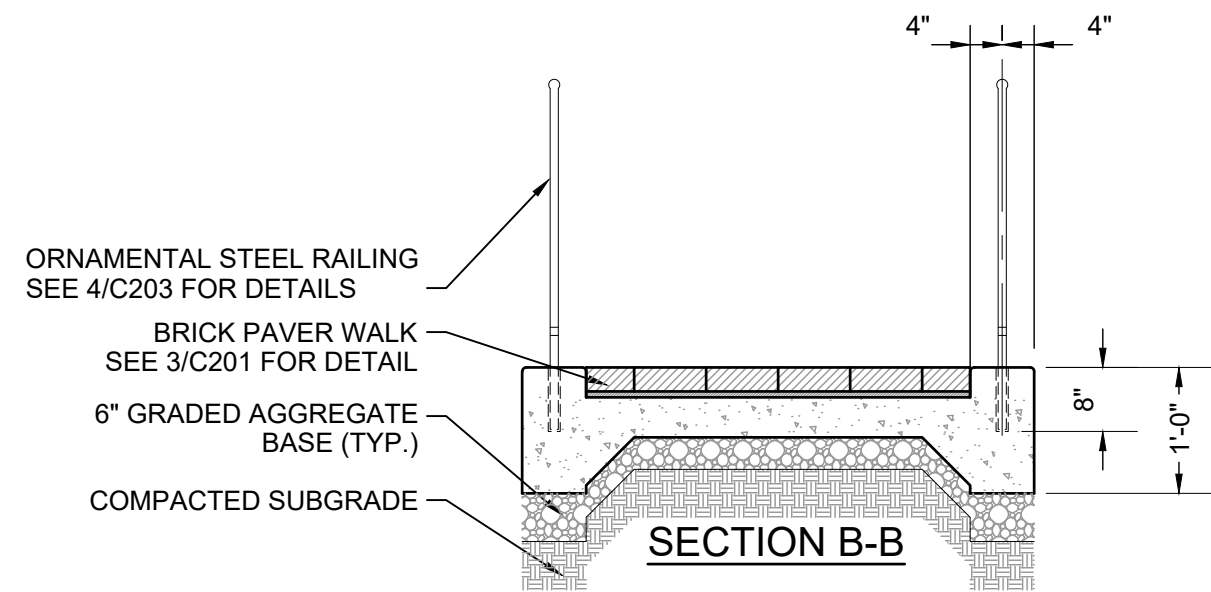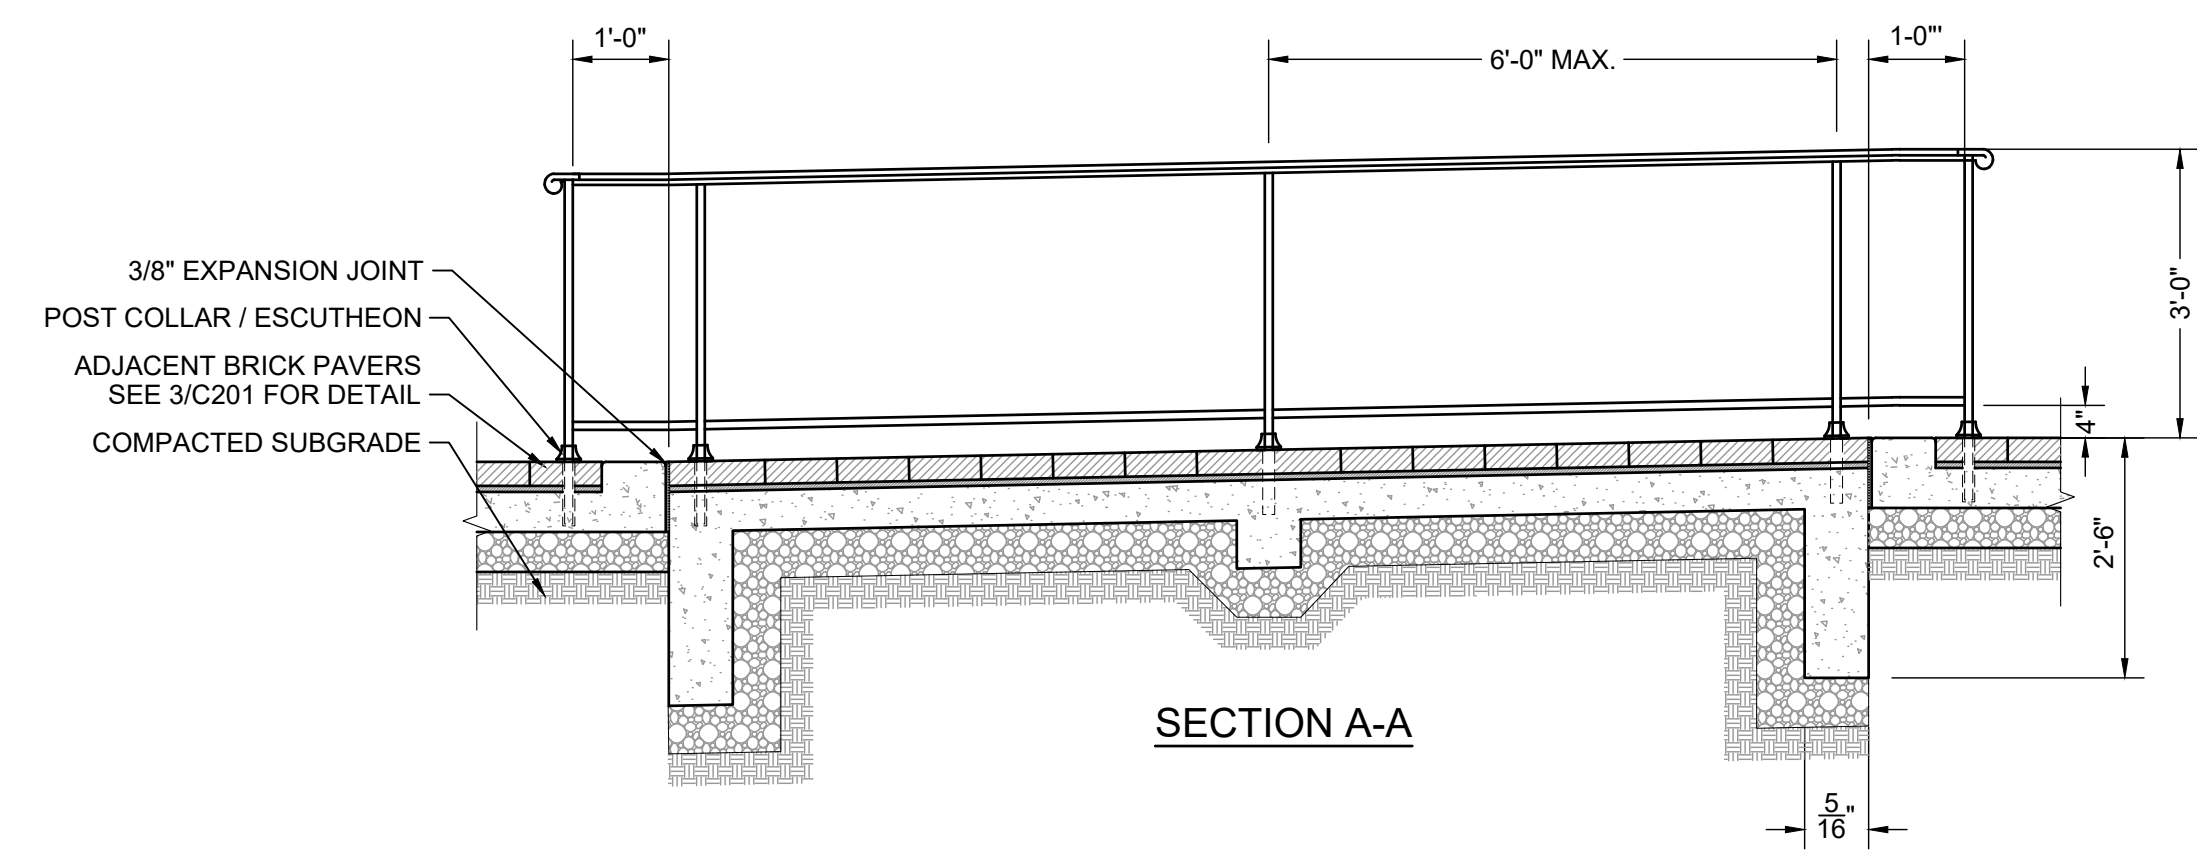


- NOTES:**
1. RAILINGS & POST TO BE SHOP FABRICATED OF 1" SQUARE POWDER COATED STEEL POST WITH ALL JOINTS CONTINUOUSLY WELDED. POWDER COAT COLOR TO MATCH EXISTING CAMPUS RAILING.
 2. TOP OF RAILING TO BE 36" ABOVE WALKING SURFACE.
 3. ALL CONCRETE TO BE SHA MIX NO. 3.
 4. ALL EXPOSED CONCRETE EDGE RADII SHALL BE 1/2".
 5. RAILING POSTS SHALL BE INSTALLED AT A DEPTH OF 8" INTO CONCRETE. CONCRETE SHALL BE CORE DRILLED AND POST SET WITH NON-SHRINK GROUT.
 6. WALKING SURFACE TO RECEIVE LIGHT BRUSHED NON-SLIP FINISH THAT IS PERPENDICULAR TO THE DIRECTION OF PEDESTRIAN TRAVEL. (SEE SPECS)
 7. UNLESS OTHERWISE SHOWN ON PLAN, ALL REBAR SHALL HAVE A MINIMUM CLEARANCE OF 3" FROM SURFACE.
 8. EXPANSION AND CONTRACTION JOINTS SHALL BE SPACED IN ACCORDANCE WITH EXPANSION JOINT DETAIL.
 9. ALL EXPANSION JOINTS ON RAMP SHALL BE DOWELED AS SHOWN.

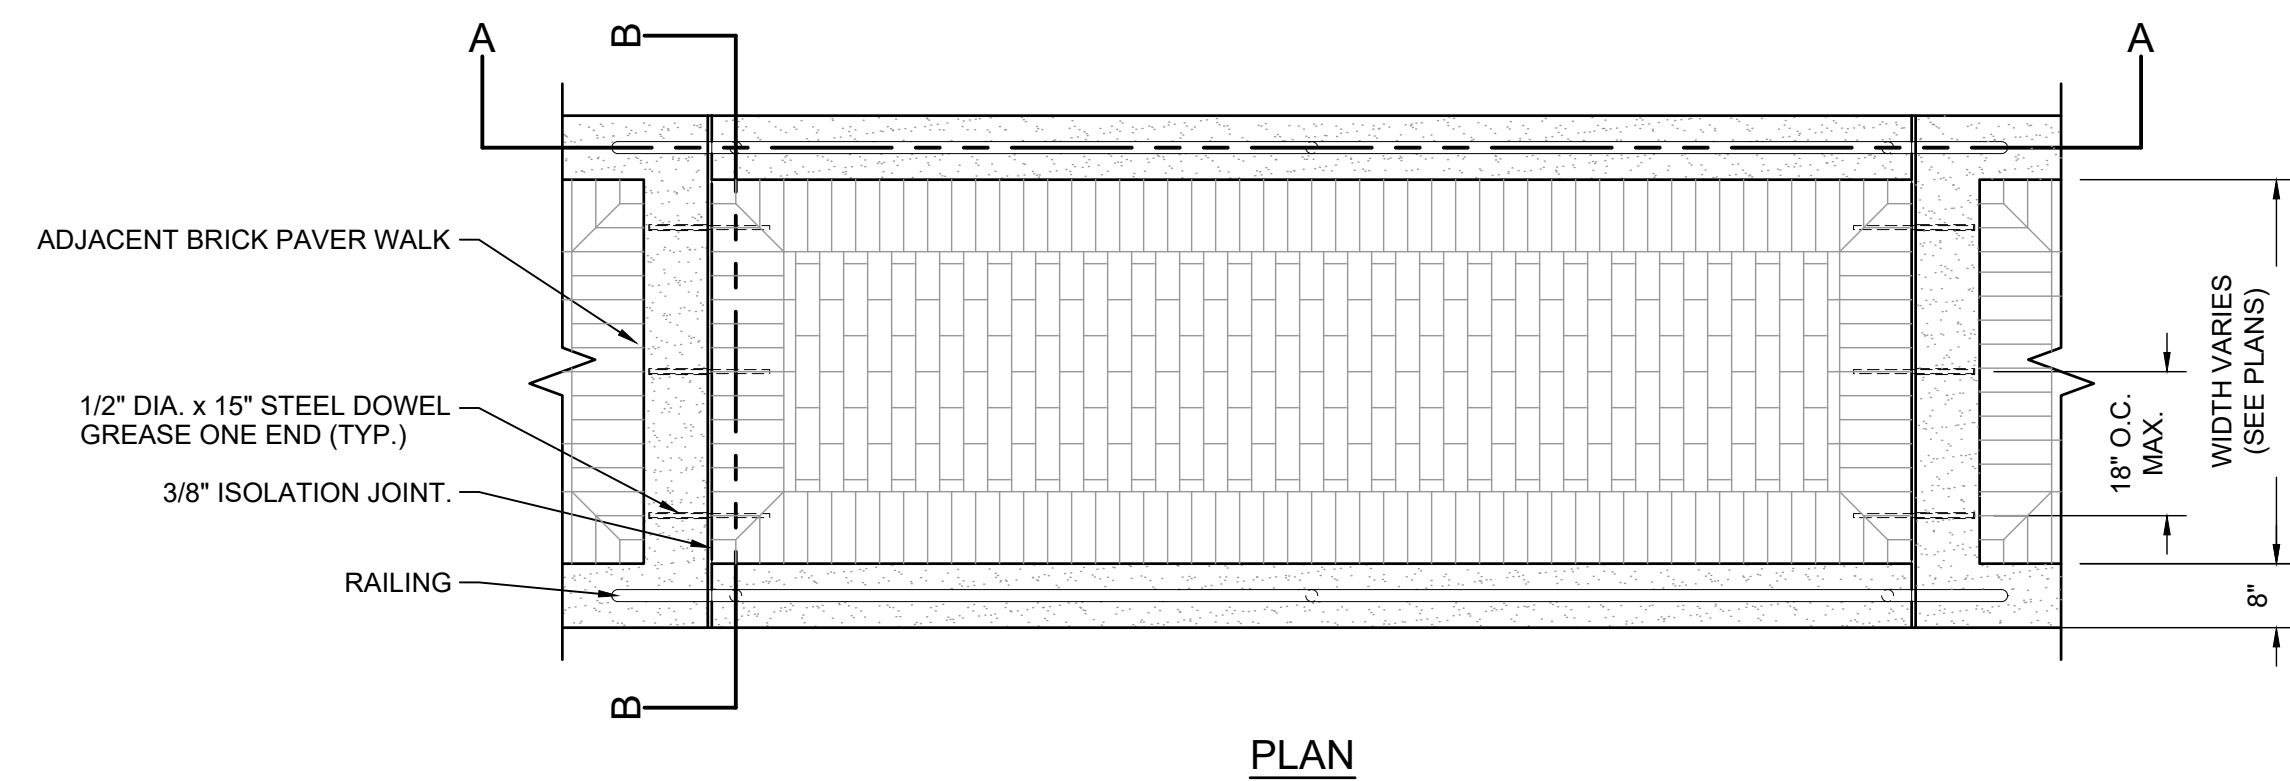


PLAN

1 RAMP 1" = 1'-0"

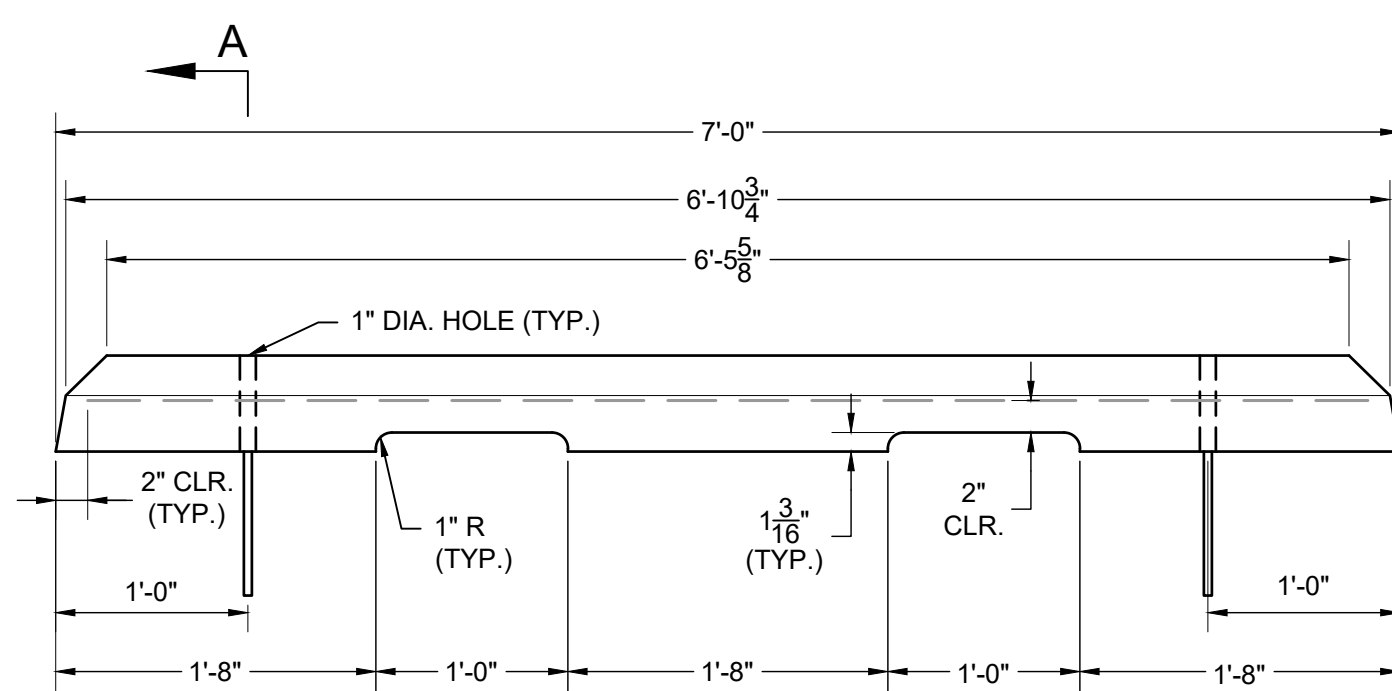


ELEVATION

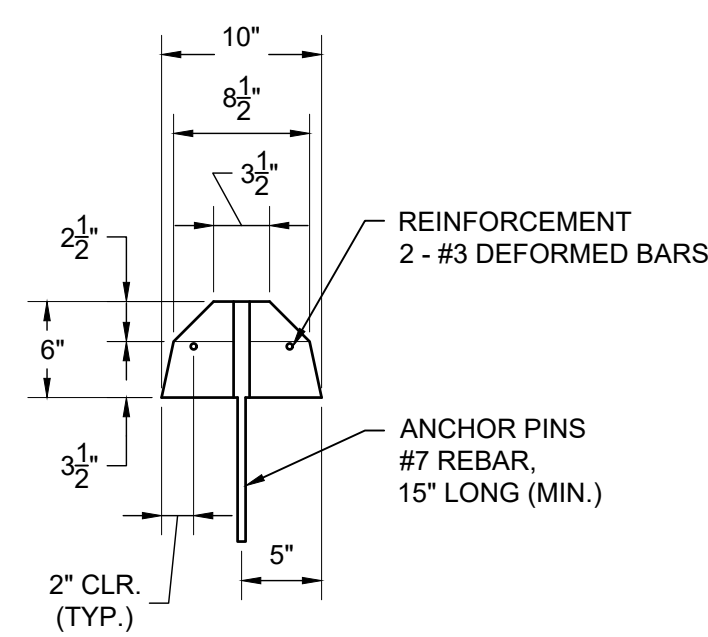


SECTION A-A (TYPICAL - TYPE 1-11)

- NOTES:**
1. 4500 PSI CONCRETE
 2. ANCHOR PINS SHALL NOT PROTRUDE ABOVE TOP OF WHEELSTOP
 3. WHEELSTOPS 24" FROM EDGE OF PAVING.


4 PRECAST CONCRETE WHEEL STOP NOT TO SCALE

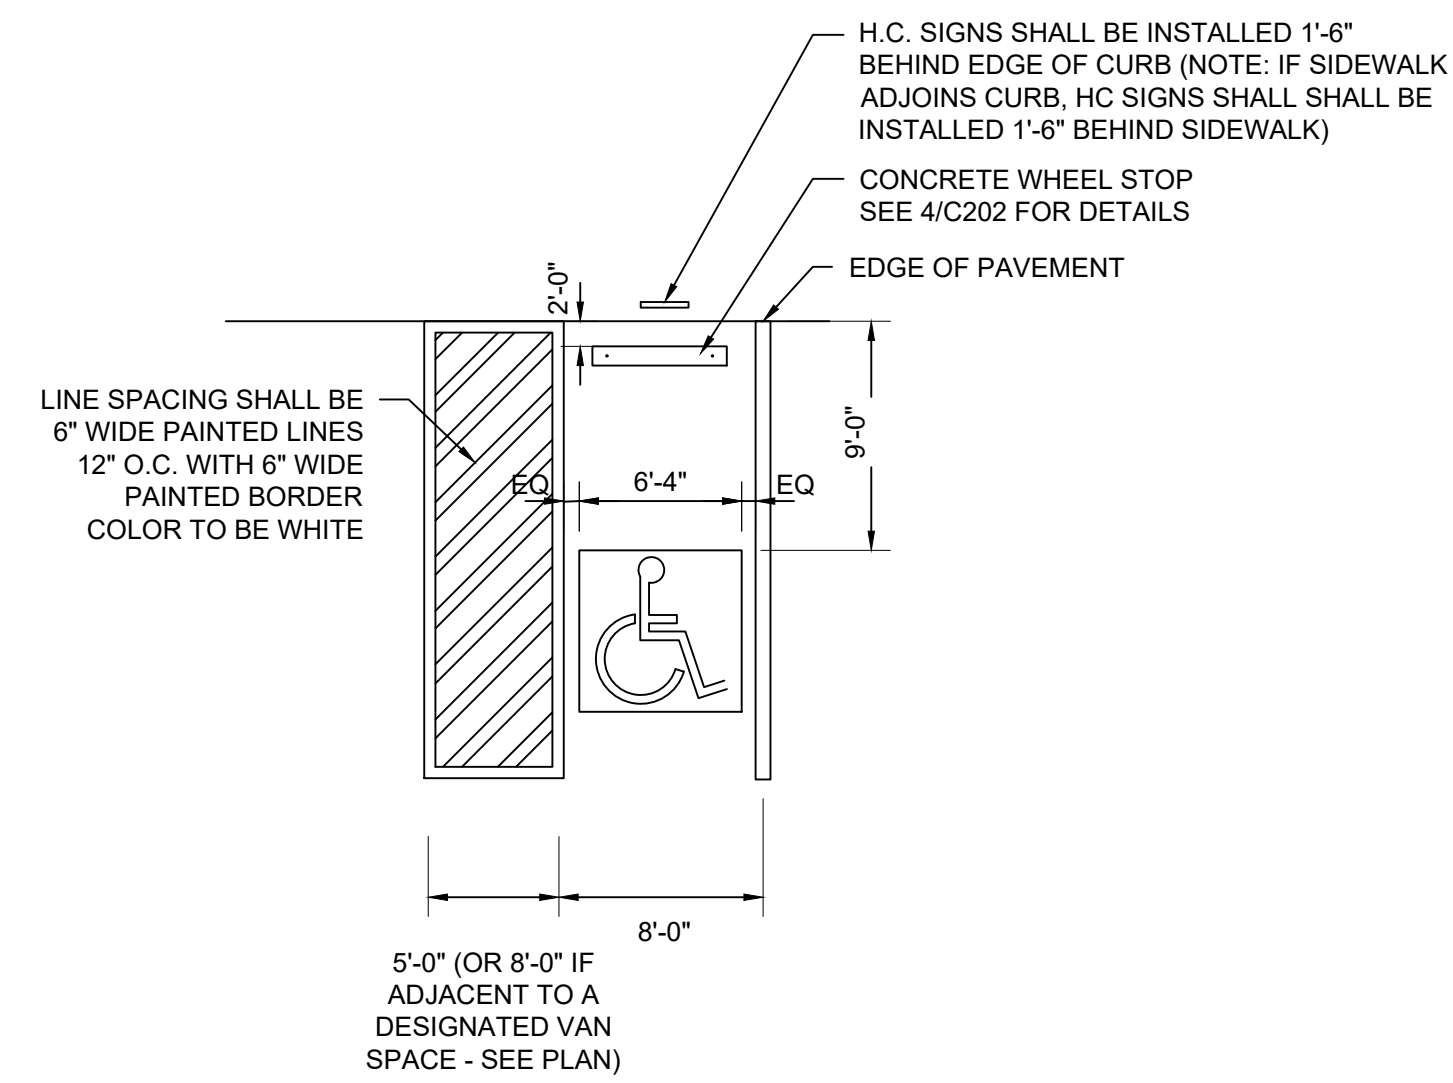

2 TYPICAL HANDICAP PARKING SPACE STRIPING NOT TO SCALE

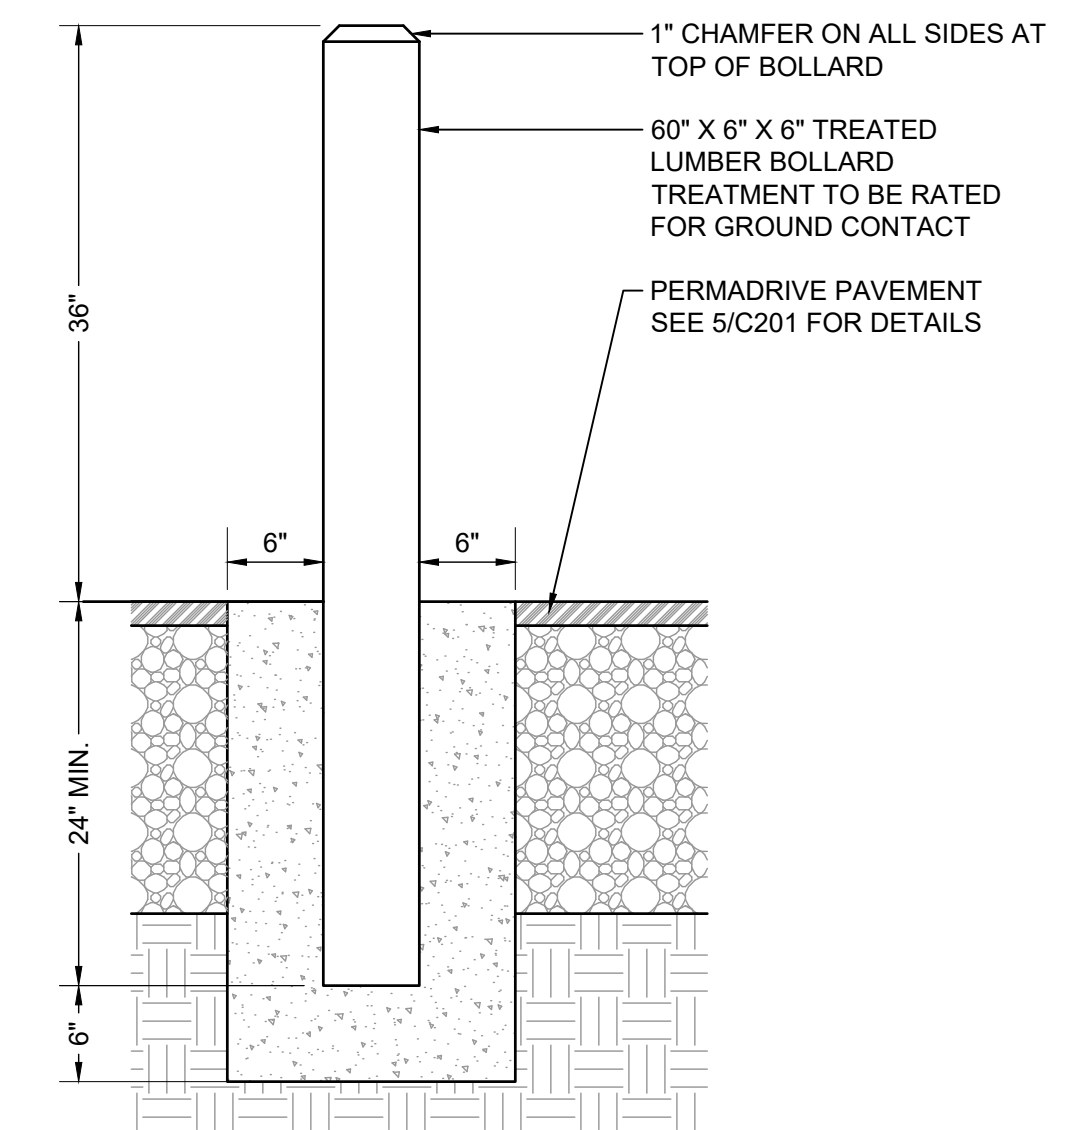

3 WOOD BOLLARD 1" = 1'-0"

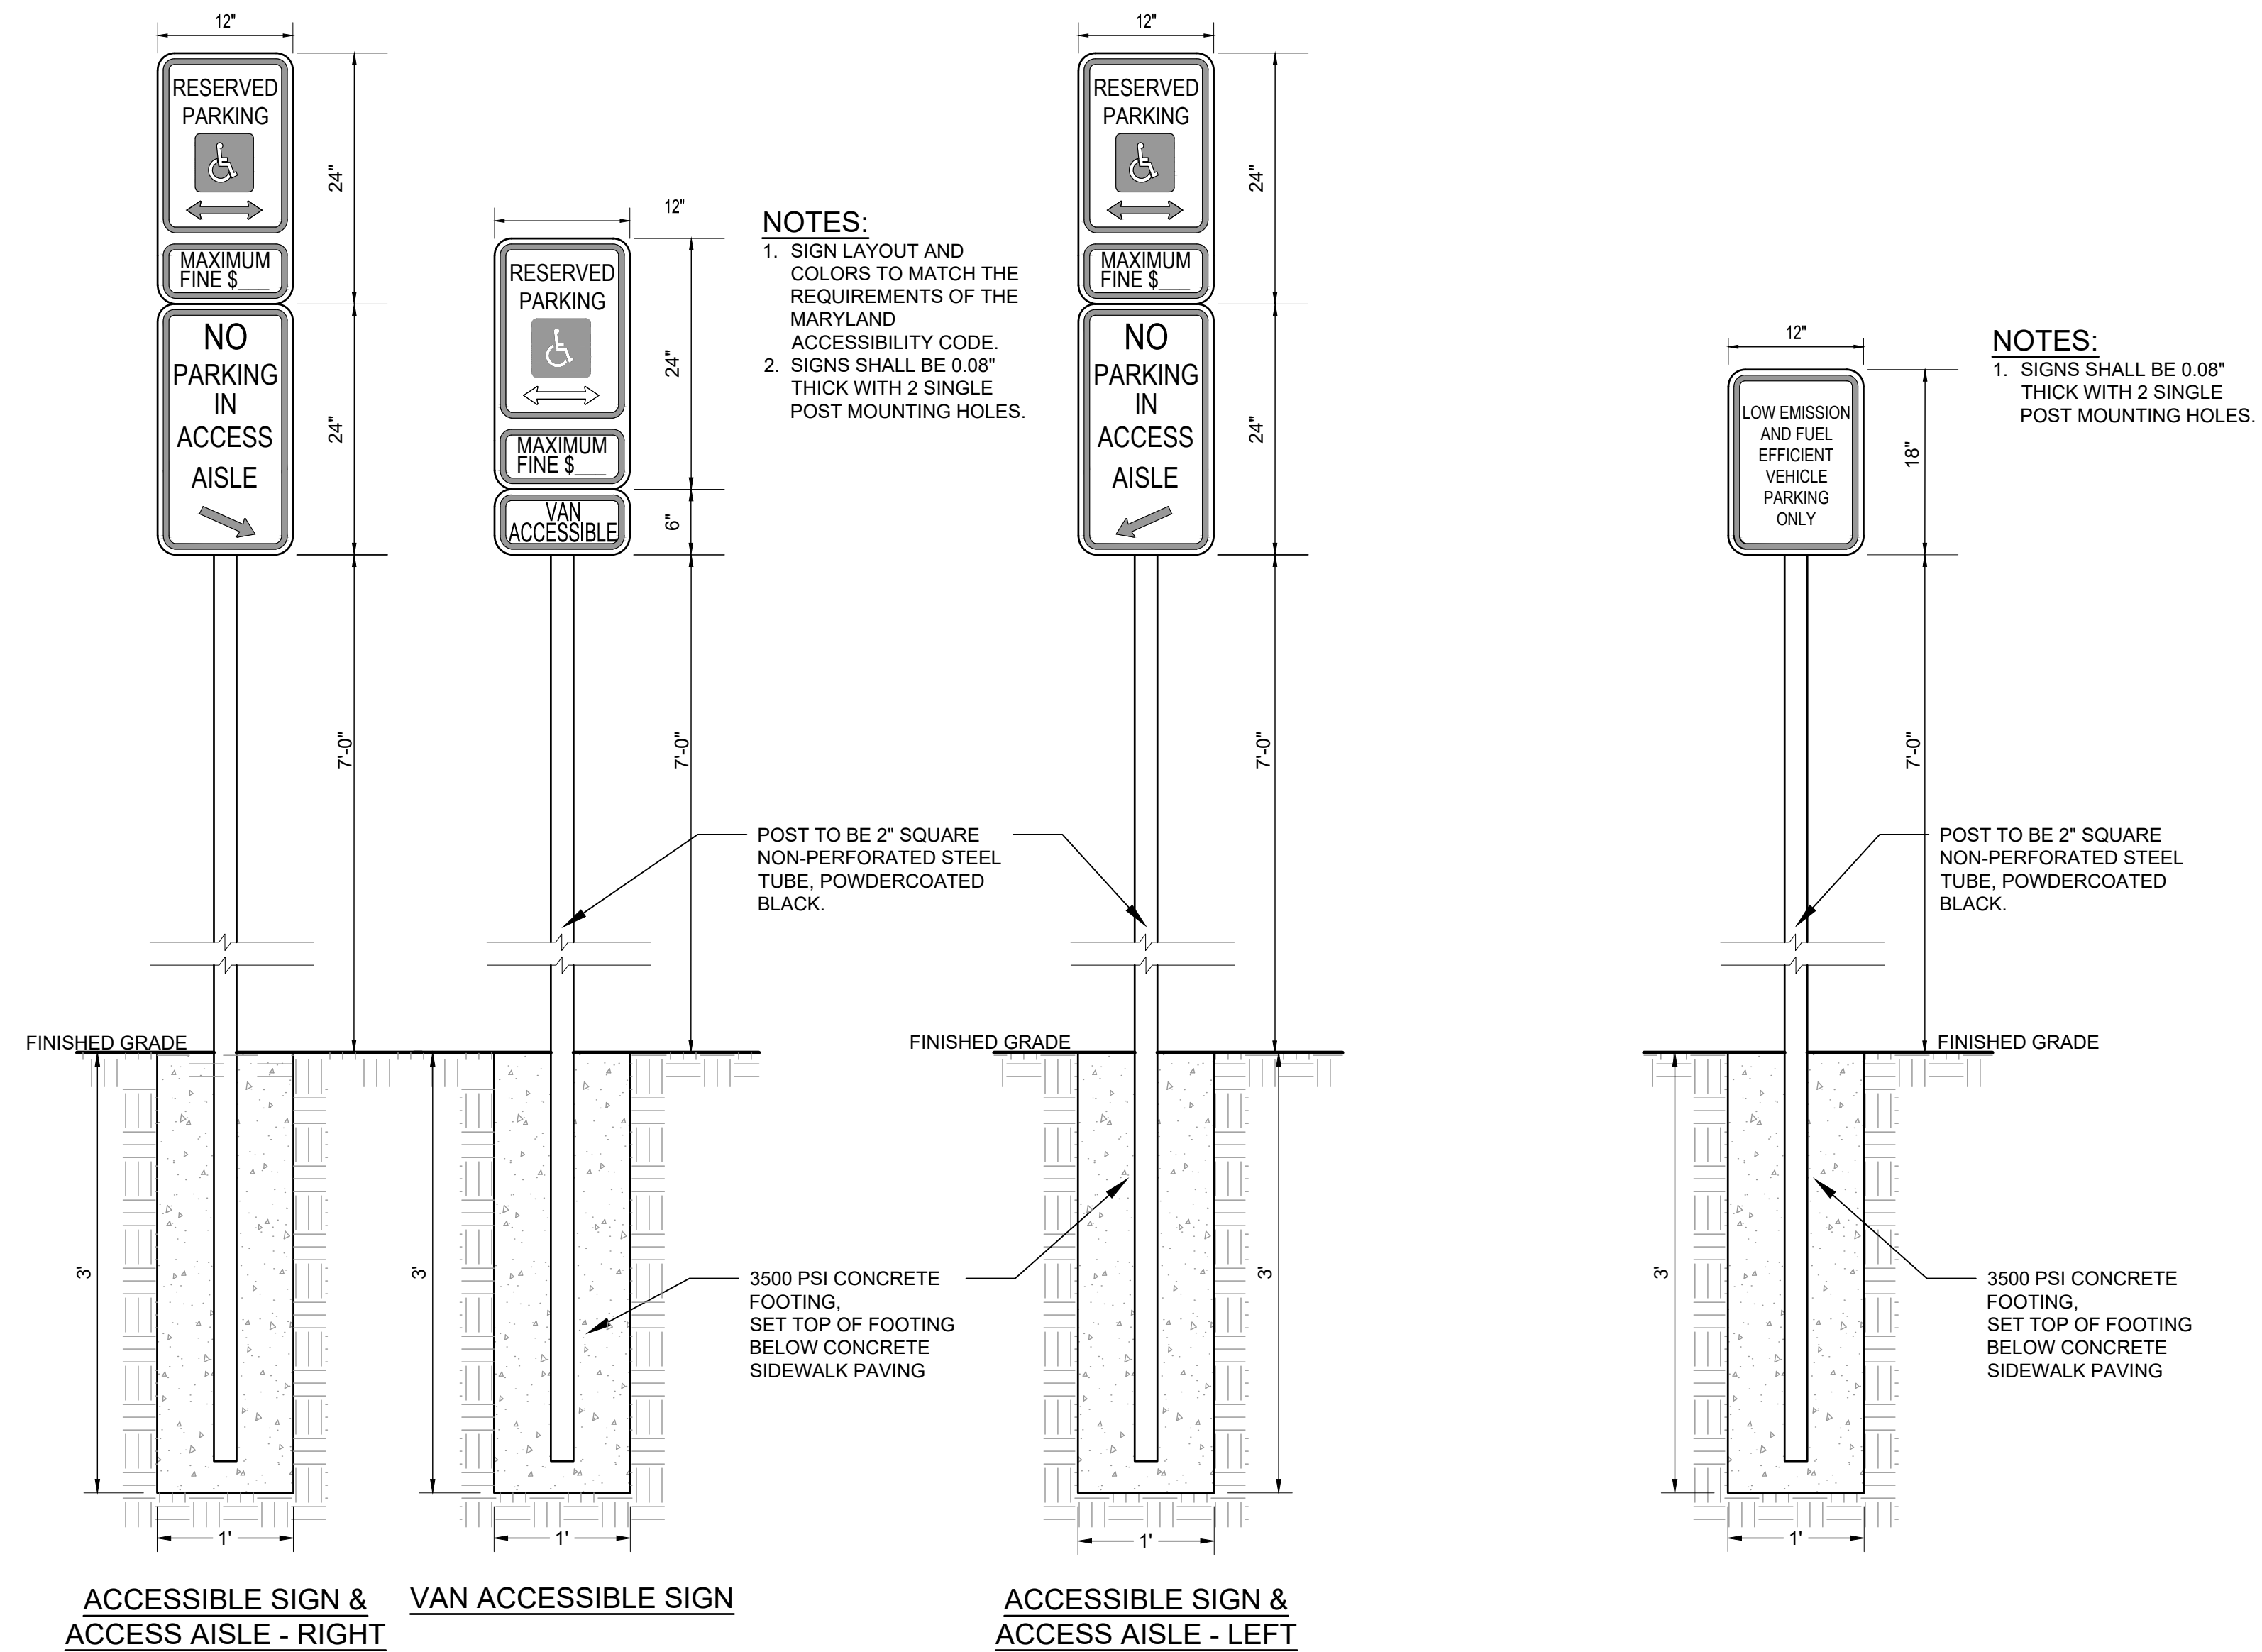

5 HANDICAP ACCESSIBLE SIGNAGE 1" = 1'-0"

6 LEFE VEHICLE SIGNAGE 1" = 1'-0"





PROFESSIONAL CERTIFICATION
I HEREBY CERTIFY THAT THESE DOCUMENTS WERE PREPARED OR APPROVED BY ME, AND THAT I AM A DULY LICENSED PROFESSIONAL ENGINEER UNDER THE LAWS OF THE STATE OF MARYLAND. LICENSE NO. 42977. EXPIRATION DATE: 06/07/2023.

REVISIONS

#	DATE	DESCRIPTION



DRAWN BY: ZJR CHECKED BY: PCS
DATE: 12/09/2022 PROJECT #: 08038
SCALE: AS SHOWN
DRAWING NAME:
SITE DETAILS

DRAWING NO.:

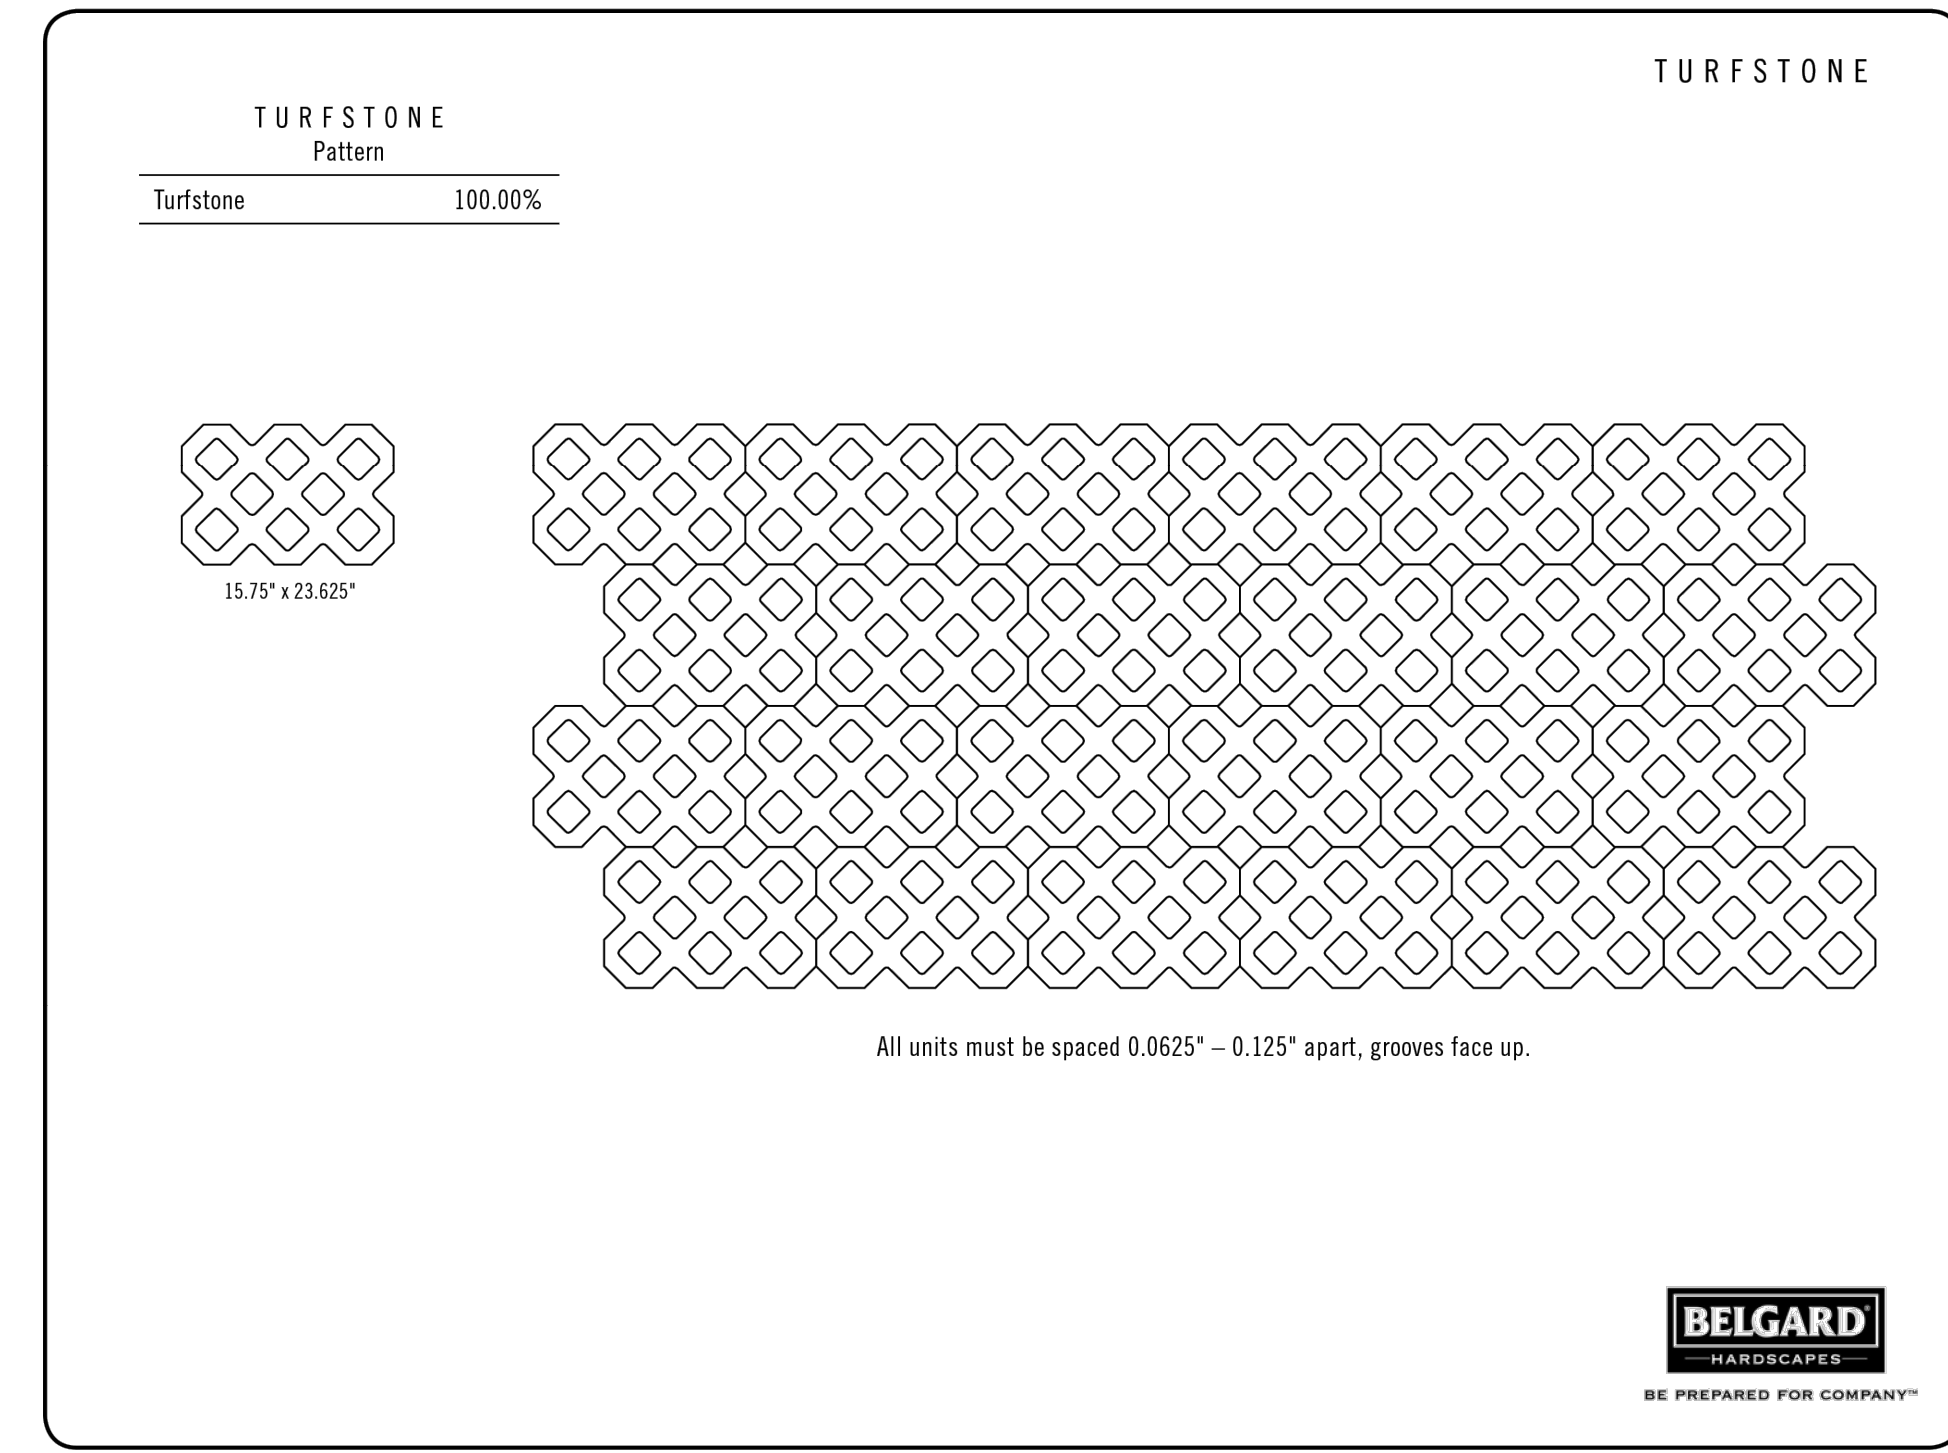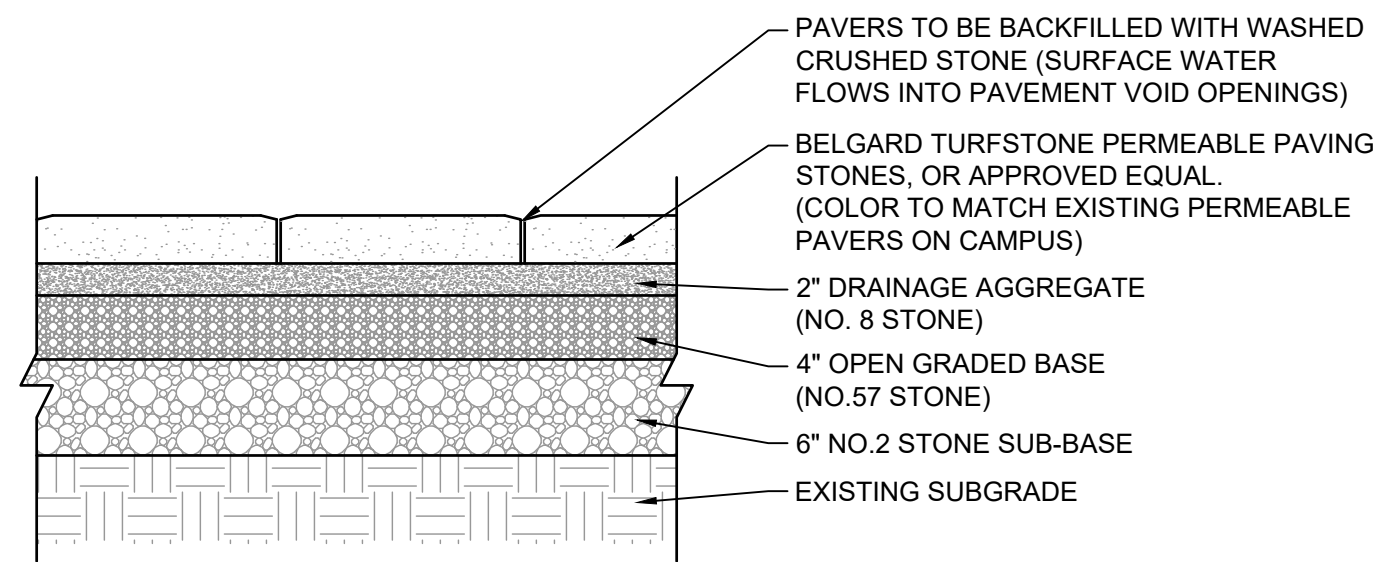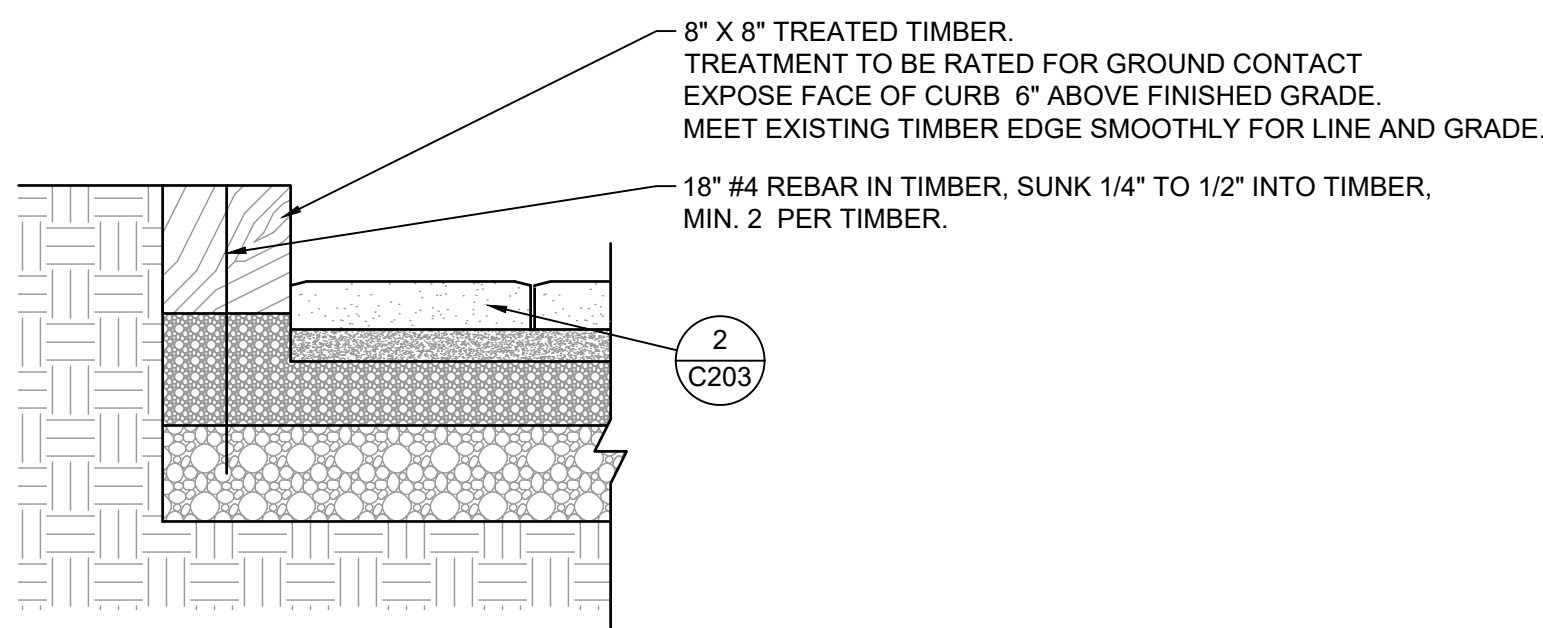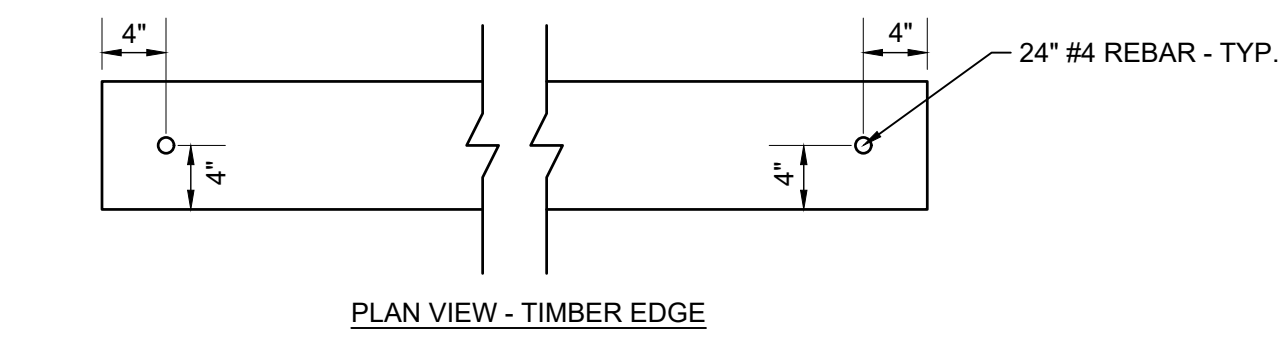


1 **TIMBER EDGING**
 1" = 1'-0"

2 **TURFSTONE PERMEABLE PAVERS**
 1" = 1'-0"

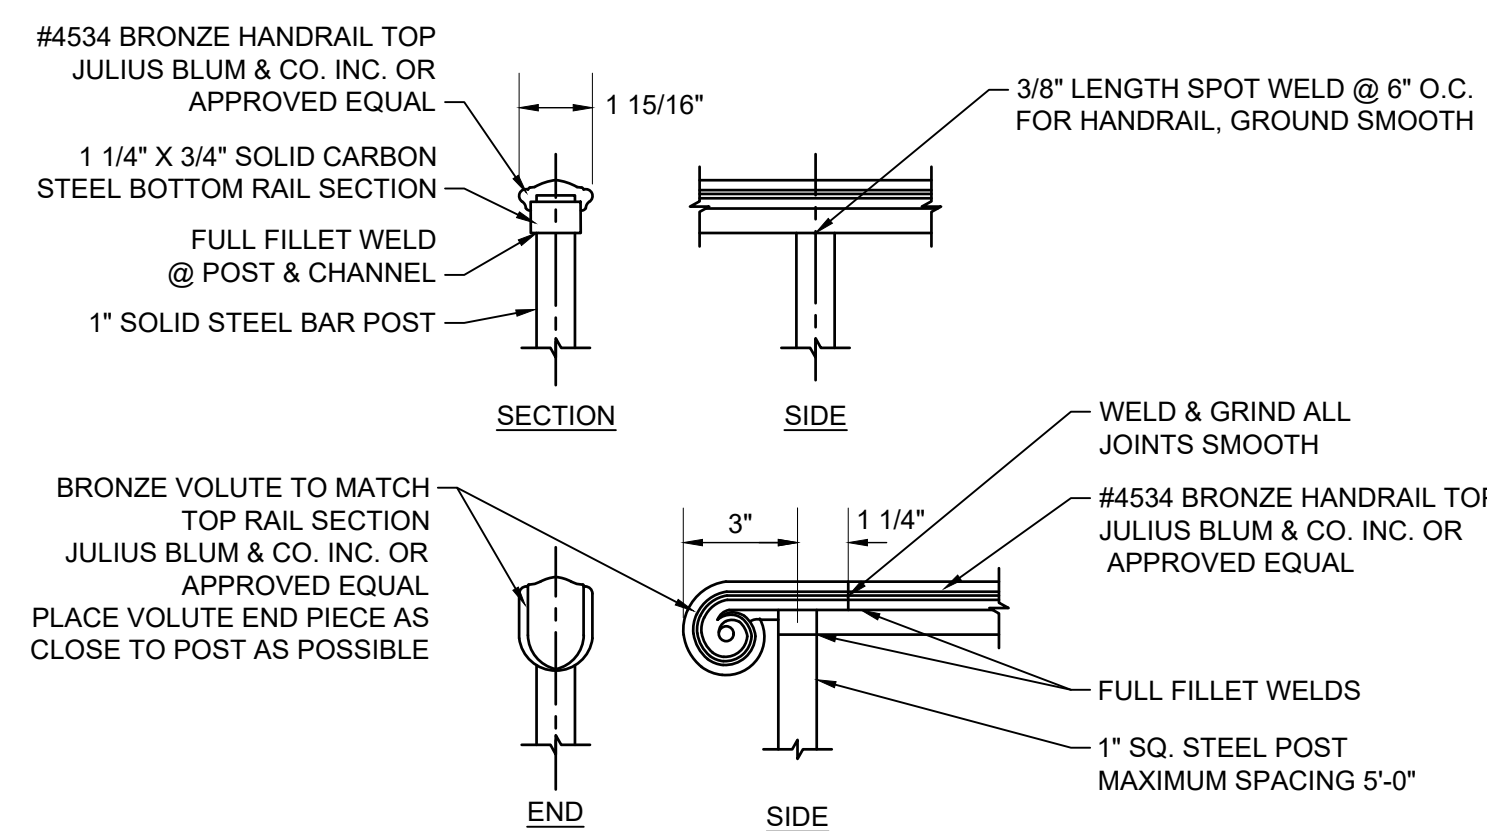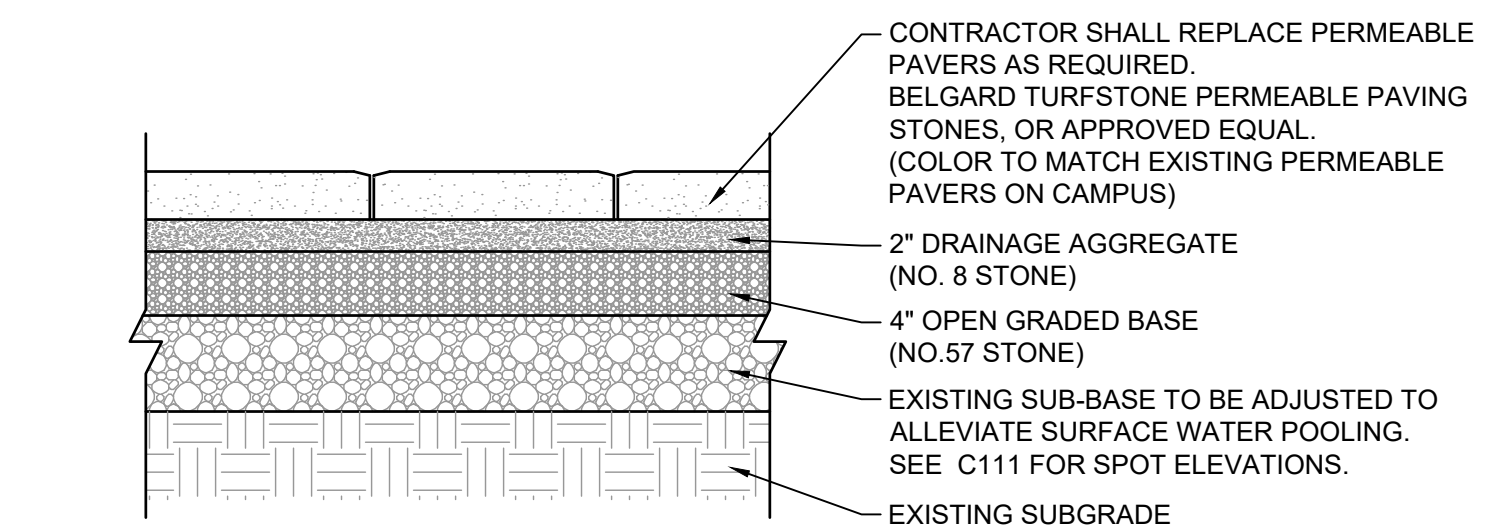


3 **PERMEABLE PAVER SUB BASE REPAIR**
 1" = 1'-0"

4 **ORNAMENTAL STEEL RAILING**
 NOT TO SCALE

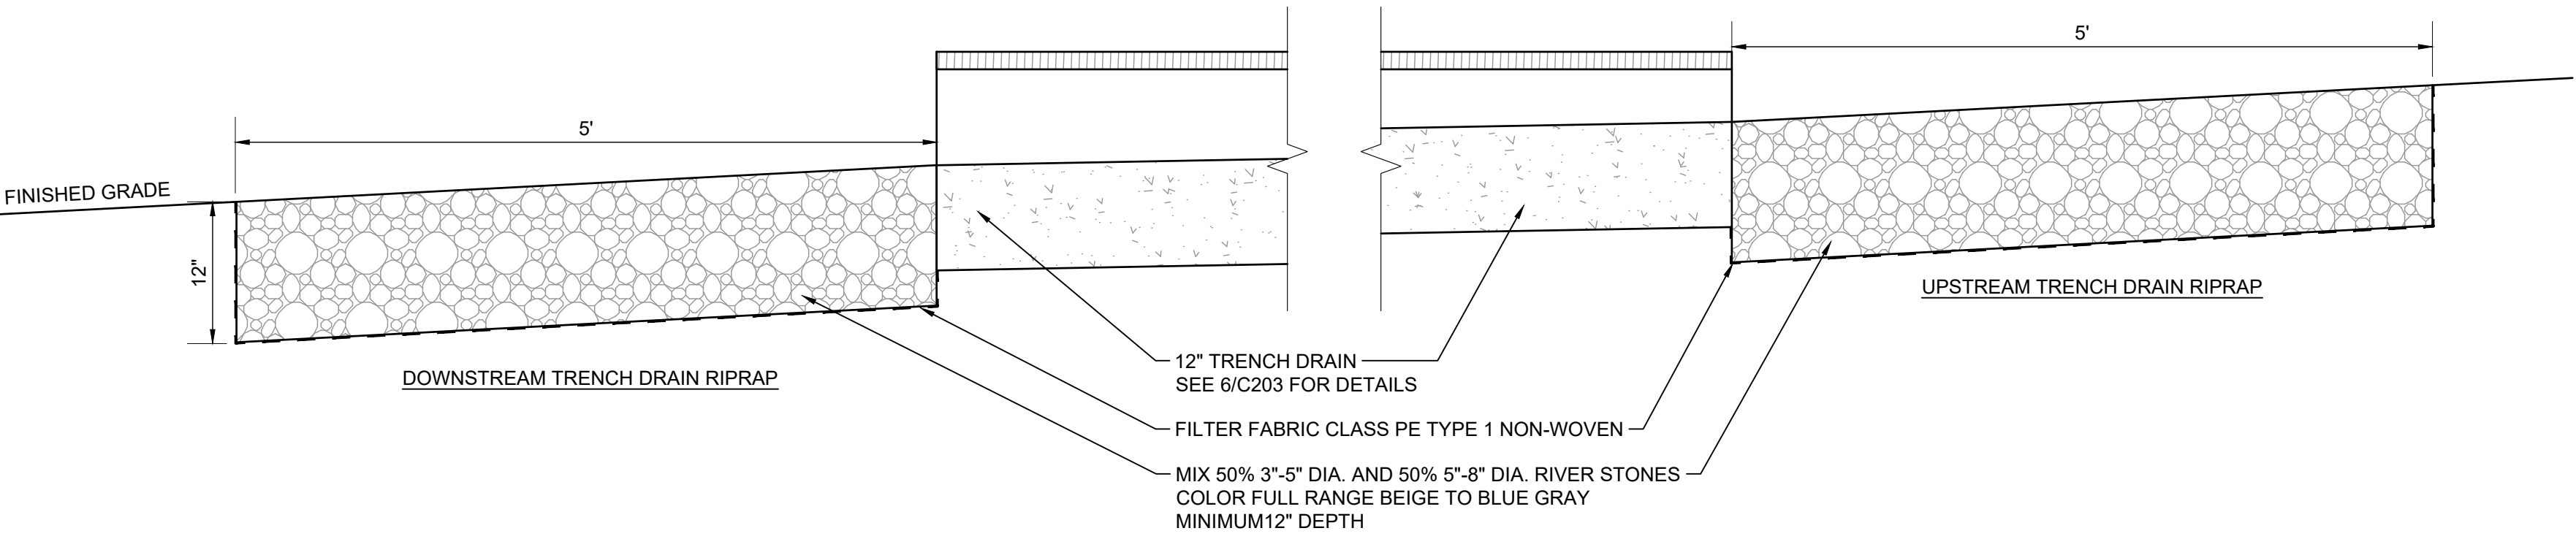

5 **TRENCH DRAIN RIP RAP**
 1" = 1'-0"

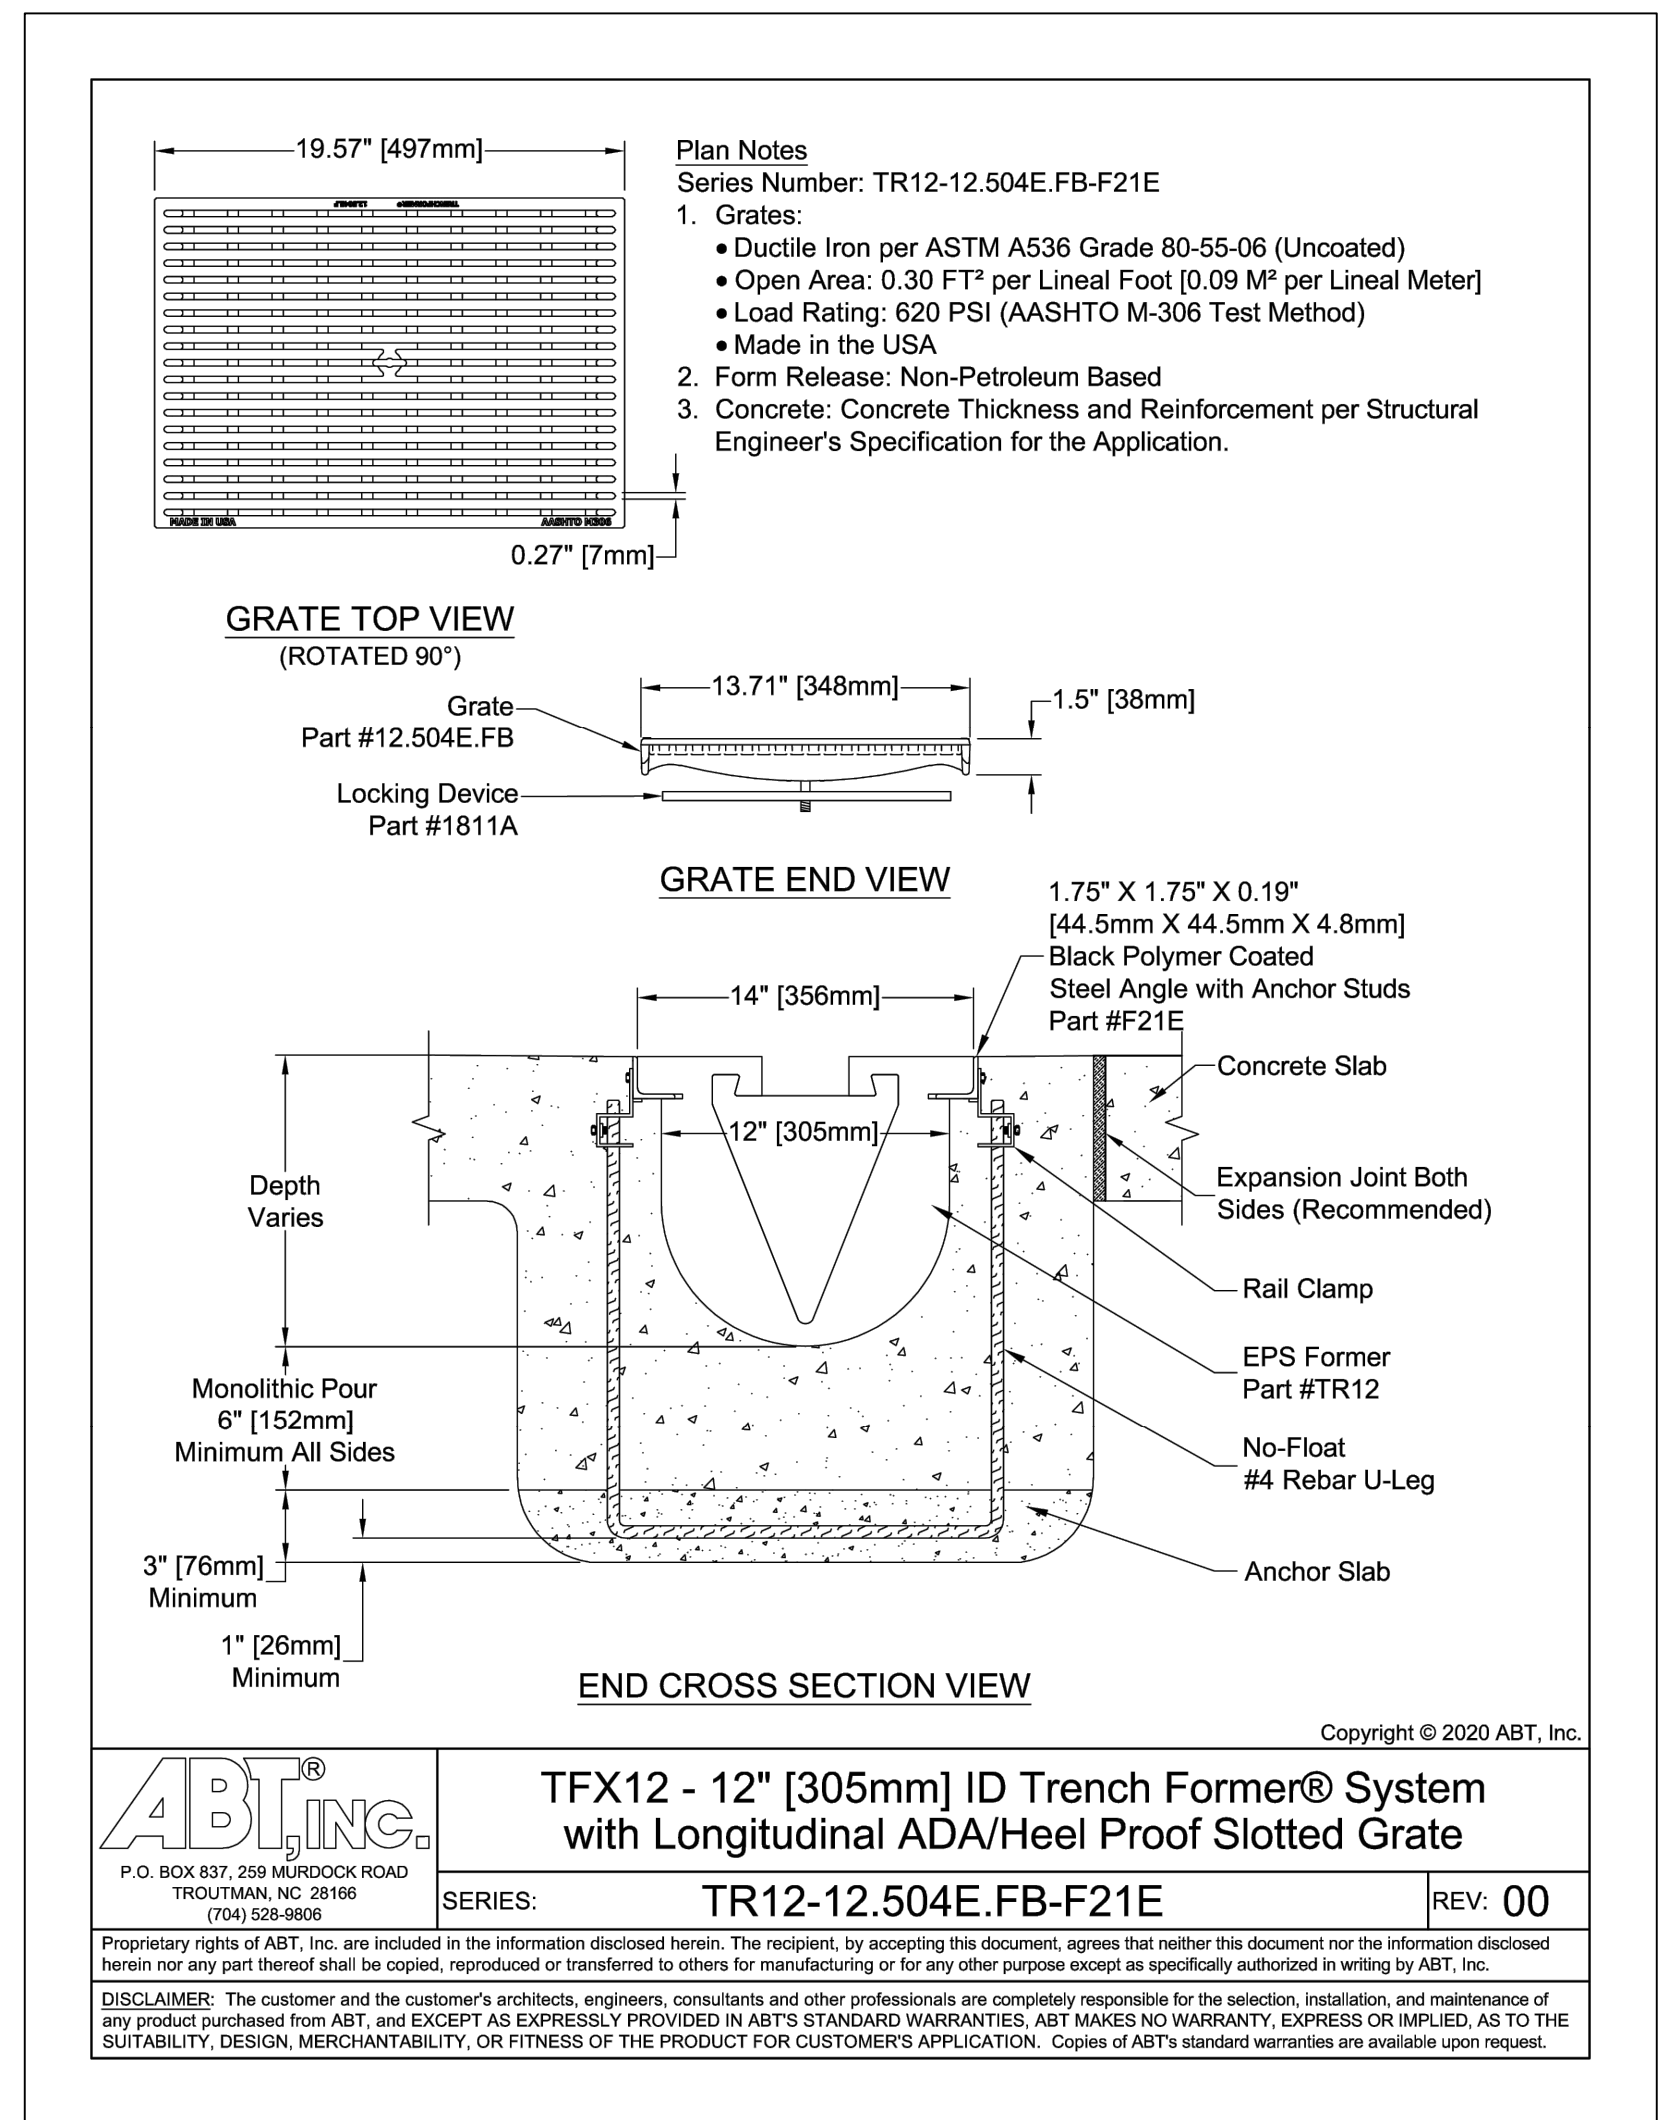

6 **TRENCH DRAIN - BASIS OF DESIGN**
 NOT TO SCALE

PROFESSIONAL CERTIFICATION
 I HEREBY CERTIFY THAT THESE DOCUMENTS WERE
 PREPARED OR APPROVED BY ME, AND THAT I AM A DULY
 LICENSED PROFESSIONAL ENGINEER UNDER THE LAWS
 OF THE STATE OF MARYLAND, LICENSE NO. 42977.
 EXPIRATION DATE: 06/07/2023.

REVISIONS

#	DATE	DESCRIPTION

DRAWN BY: ZJR CHECKED BY: PCS
 DATE: 12/09/2022 PROJECT #: 08038
 SCALE: AS SHOWN
 DRAWING NAME:
SITE DETAILS

DRAWING NO.:
C203

© SITE RESOURCES, INC. Z:\08108038-St. Marys College ArneAunde\HalDwg\WHIC Pkg_Lot\C111_Site Plan.dwg-C203 Nov 30, 2022 04:03pm zjr

SMITHGROUP

SMITHGROUP
1700 New York Ave NW, Suite 100
WASHINGTON, DC 20006
T 202.842.2100
www.smithgroup.com

WFT
MEP Engineers
1801 Research Blvd Suite 100
Rockville, MD 20850
T 301.230.0811

A&F Engineers
Structural Engineer
1112 16th NW Unit 820
Washington, DC 20036
T 202.628.1600

Site Resources
Civil Engineer
14315 Jamettsville Pike, P.O. Box 249
Pikesville, MD 21113-0249
T 410.853.3388

Michael Vergason Landscape Architects
Landscape Architect
907 King Street, Suite 200
Alexandria, VA 22314
T 703.838.5557

ISSUED FOR	REV	DATE

SITE LIGHTING	05.02.23
RPT 005	03.03.23
ADDENDUM 01	04.26.22
ISSUED FOR PERMIT	03.04.22
100% CONSTRUCTION DOCUMENTS	01.09.12

SEALS AND SIGNATURES




PROFESSIONAL CERTIFICATION:
I CERTIFY THAT THESE DOCUMENTS WERE PREPARED
OR APPROVED BY ME, AND THAT I AM A DULY LICENSED
ENGINEER UNDER THE LAWS OF THE STATE OF MARYLAND.
LICENSE NUMBER 7907
EXPIRATION DATE 06-26-2023

KEY PLAN

DRAWING TITLE
**SITE LIGHTING
CALCULATION**

SCALE 11512.000
PROJECT NUMBER
DRAWING NUMBER **E1.2**


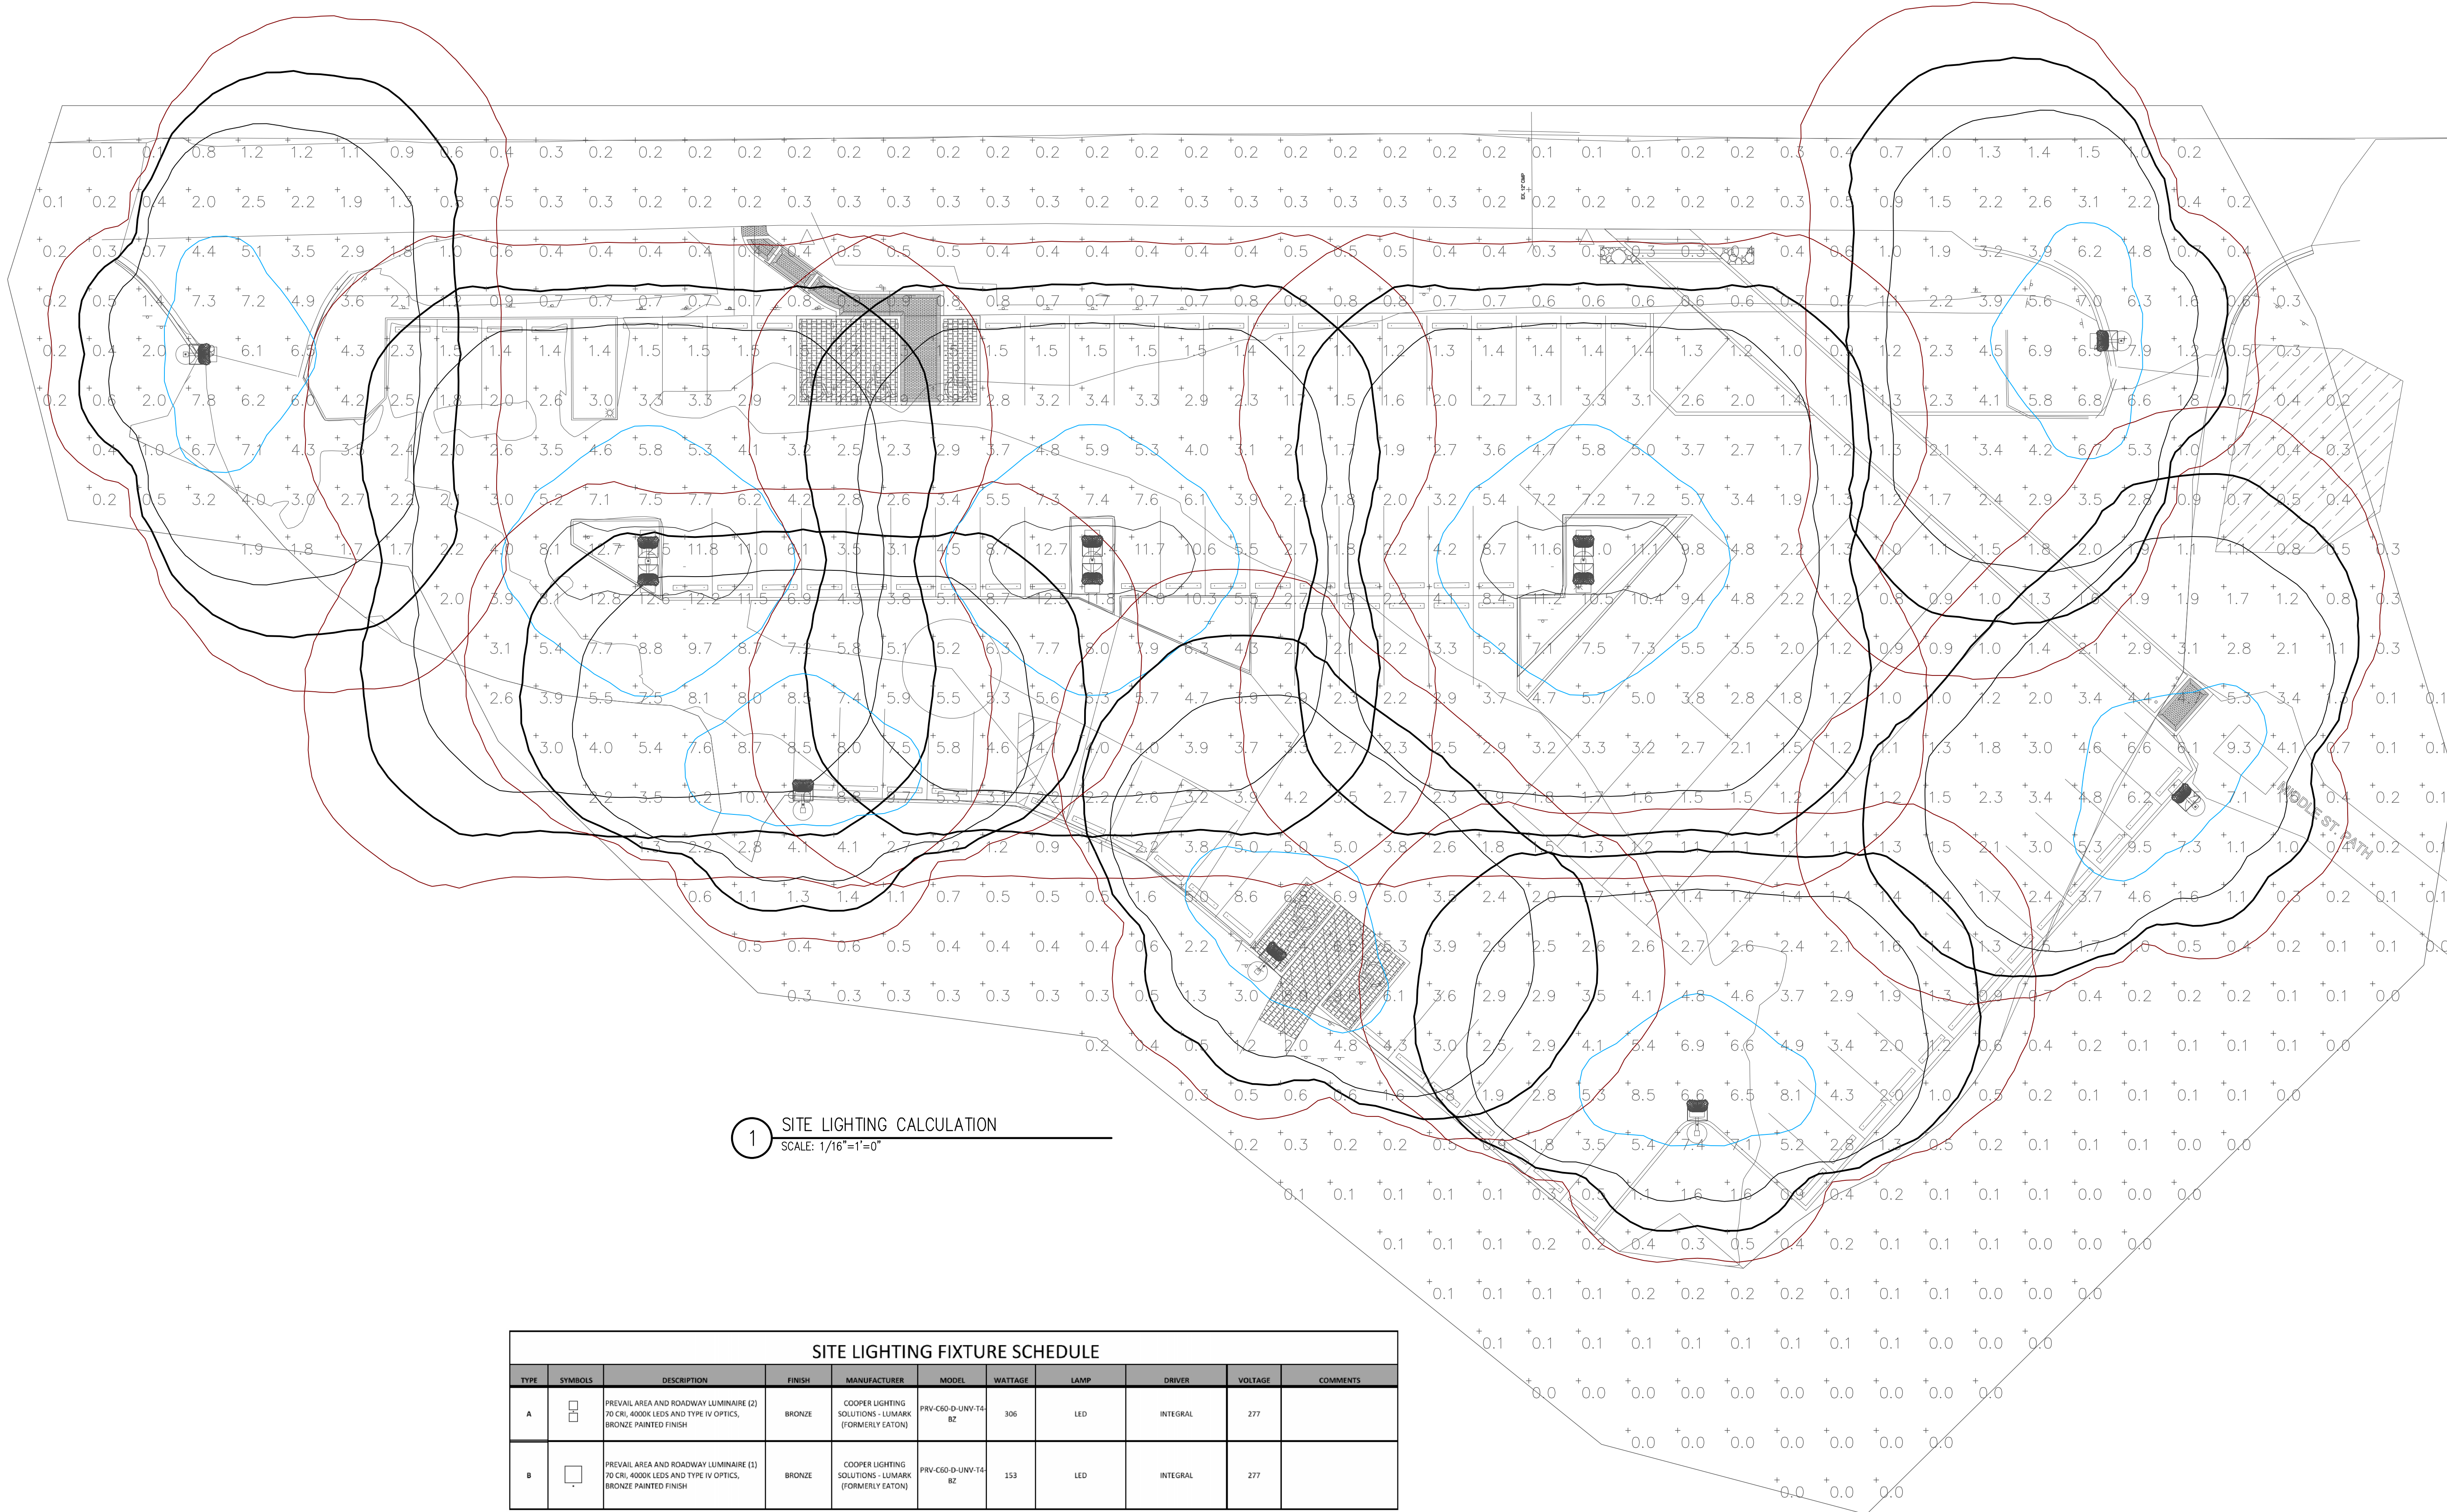


1 SITE LIGHTING CALCULATION
SCALE: 1/16"=1'-0"

SITE LIGHTING FIXTURE SCHEDULE										
TYPE	SYMBOLS	DESCRIPTION	FINISH	MANUFACTURER	MODEL	WATTAGE	LAMP	DRIVER	VOLTAGE	COMMENTS
A		PREVALE AREA AND ROADWAY LUMINAIRE (2) F0 CR. 400K LEDS AND TYPE IV OPTICS, BRONZE PAINTED FINISH	BRONZE	COOPER LIGHTING SOLUTIONS - USAMARK (FORMERLY EATON)	FRV-C60-D-UNV-14 BZ	306	LED	INTEGRAL	277	
B		PREVALE AREA AND ROADWAY LUMINAIRE (1) F0 CR. 400K LEDS AND TYPE IV OPTICS, BRONZE PAINTED FINISH	BRONZE	COOPER LIGHTING SOLUTIONS - USAMARK (FORMERLY EATON)	FRV-C60-D-UNV-14 BZ	153	LED	INTEGRAL	277	

STATISTICS					
DESCRIPTION	SYMBOL	AVG	MAX	MIN	MAX/MIN
SITE LIGHTING	+	2.6 FC	12.8 FC	0.0 FC	N/A

© SITE RESOURCES, INC. Z:\08\08038-St Marys College AnneArundel\HalDwg\WHIC Pkg_Lot\ESC101 - Existing ESC Plan.dwg-ESC101 Nov 30, 2022 04:04pm -zif

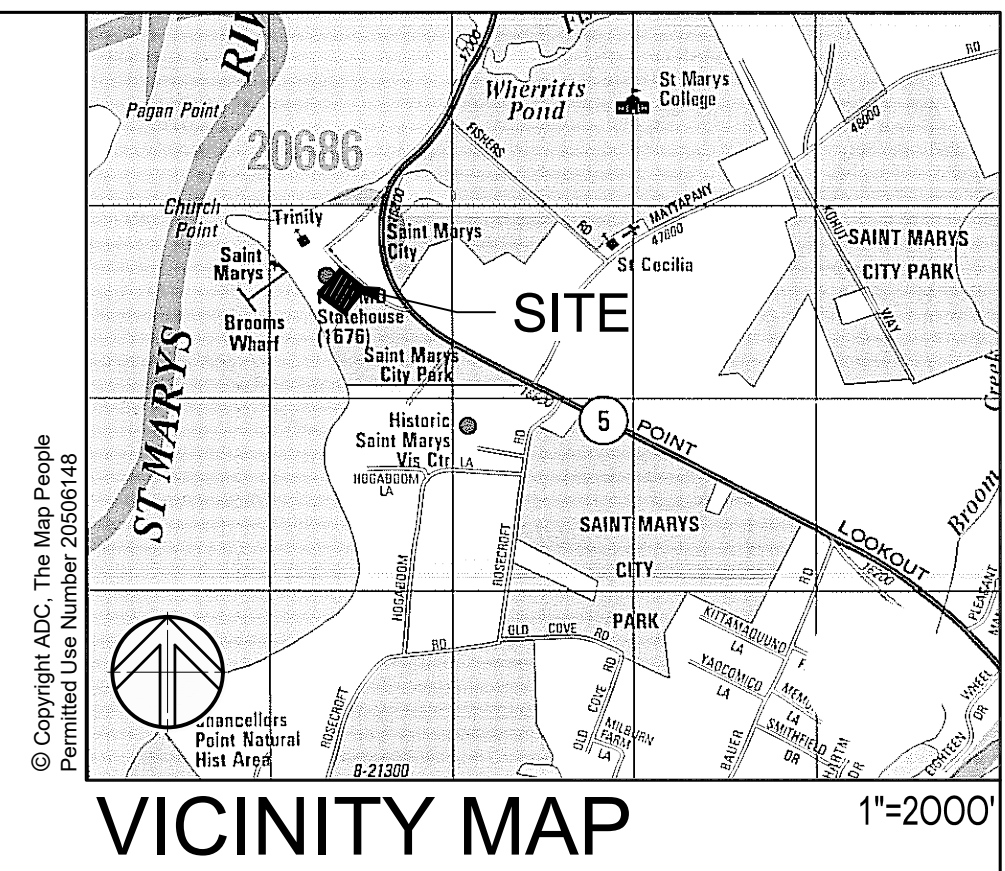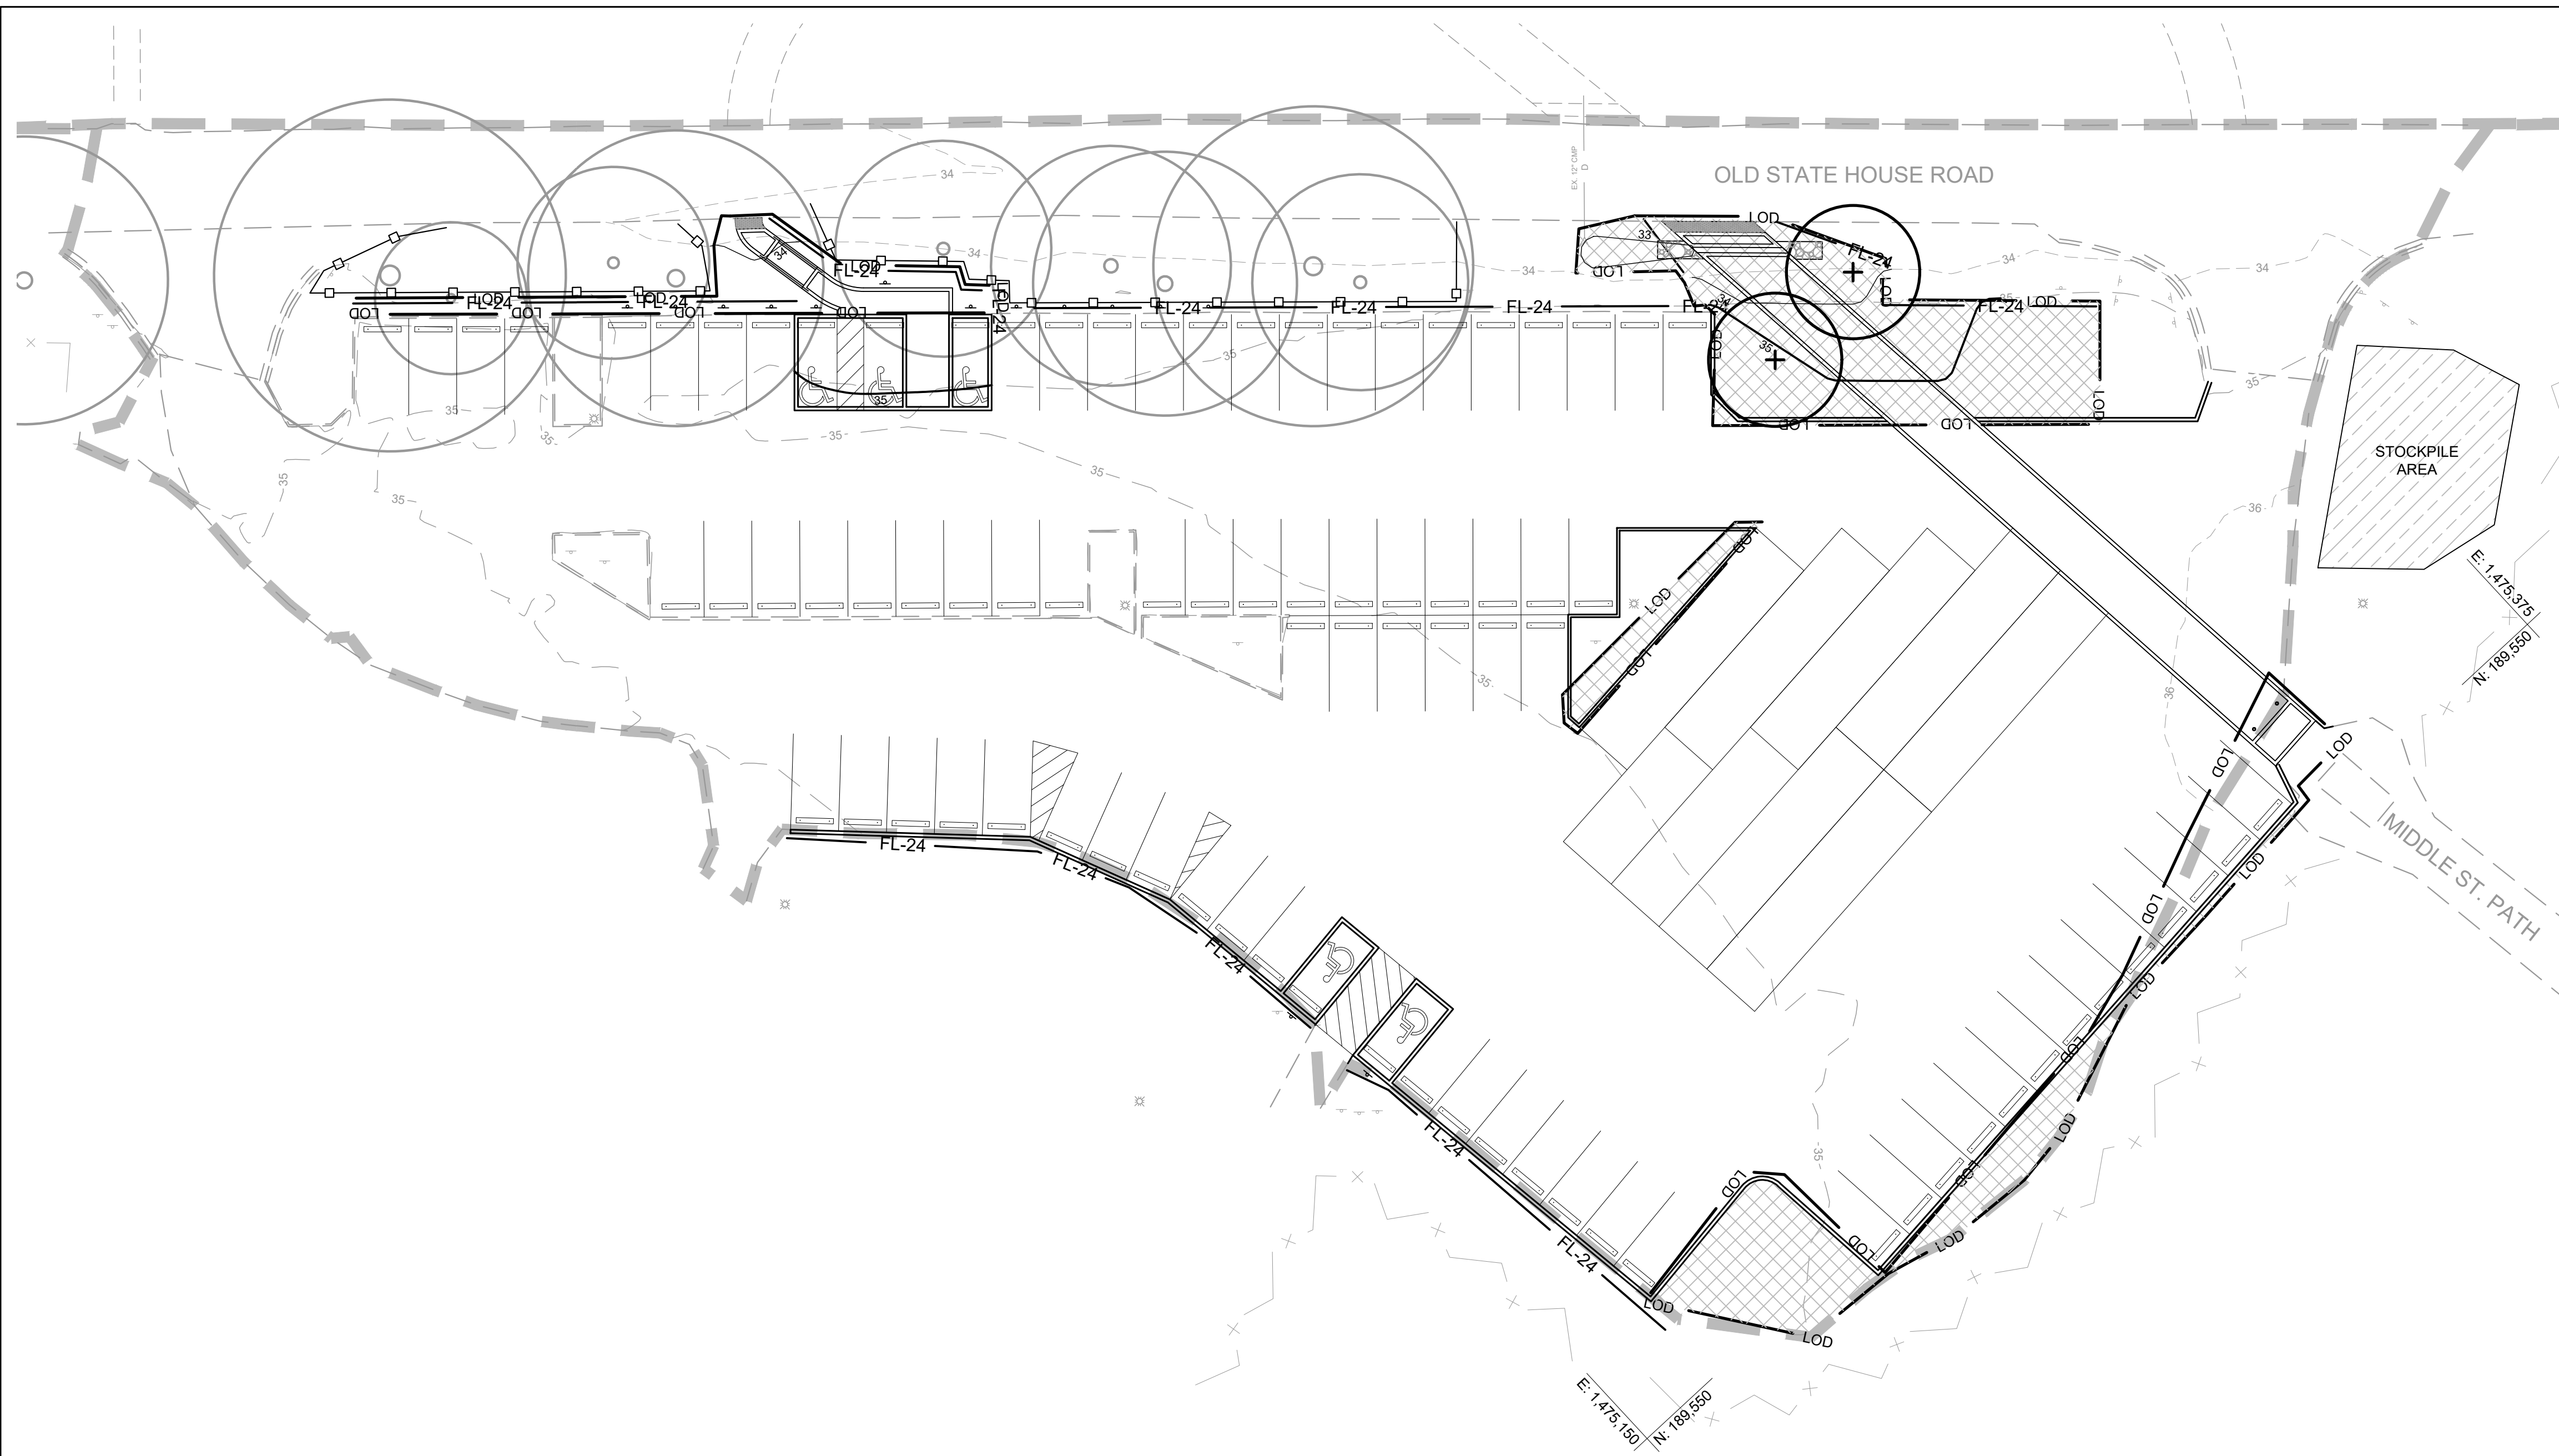

LEGEND

	EXISTING WALK
	EXISTING ROAD
	EXISTING CURB
	EXISTING FENCE
	EXISTING LIGHTING
	EXISTING STORM DRAIN
	EXISTING CONTOURS
	EXISTING TREES
	LIMIT OF TOPOGRAPHIC SURVEY
	PROPOSED PAVER SIDEWALK
	PROPOSED EDGE OF PAVING
	PROPOSED CONTOURS
	LIMIT OF DISTURBANCE
	24" FILTER LOG
	TREE PROTECTION FENCE
	SAME DAY STABILIZATION
	STOCKPILE AREA

- ESC NOTES**
1. ANY OFFSITE AREAS DISTURBED BY CONSTRUCTION VEHICLES OR EQUIPMENT SHALL BE STABILIZED IMMEDIATELY.
 2. ALL CONSTRUCTION EQUIPMENT AND VEHICLES SHALL BE CLEANED OF ALL SEDIMENT AND DEBRIS PRIOR TO LEAVING LIMIT OF DISTURBANCE.
 3. ANY NUISANCE WATER SHALL BE PUMPED TO A FILTER BAG OR SUMP PIT.
 4. TEMPORARILY STABILIZE STOCKPILE PER THE STABILIZATION SPECIFICATIONS OR COVER THE STOCKPILE WITH PLASTIC TARP AND ANCHOR AT THE END OF EACH WORK DAY. OWNER TO APPROVE OF FINAL LOCATION FOR TEMPORARY STOCKPILE.
 5. IT IS THE CONTRACTOR'S RESPONSIBILITY TO FILTER ANY SEDIMENT PRIOR TO LEAVING THE LIMITS OF DISTURBANCE
 6. CONTRACTOR SHALL BE RESPONSIBLE FOR REPLACEMENT OF EXISTING PERMEABLE PAVERS AND UNDERLYING DRAINAGE COURSES TO REMAIN IF THEY BECOME CONTAMINATED WITH SEDIMENT DURING CONSTRUCTION.

HISTORIC ST. MARY'S CITY & ST. MARY'S COLLEGE OF MARYLAND

MARYLAND HERITAGE INTERPRETIVE CENTER PARKING LOT


ST. MARY'S CITY, MD

PROFESSIONAL CERTIFICATION
 I HEREBY CERTIFY THAT THESE DOCUMENTS WERE PREPARED OR APPROVED BY ME, AND THAT I AM A DULY LICENSED PROFESSIONAL ENGINEER UNDER THE LAWS OF THE STATE OF MARYLAND. LICENSE NO. 42977.
 EXPIRATION DATE: 06/07/2023.

REVISIONS

#	DATE	DESCRIPTION

DRAWN BY: ZJR CHECKED BY: PCS
 DATE: 12/09/2022 PROJECT #: 08038
 SCALE: AS SHOWN
 DRAWING NAME:
EROSION & SEDIMENT CONTROL OVERLAY PLAN

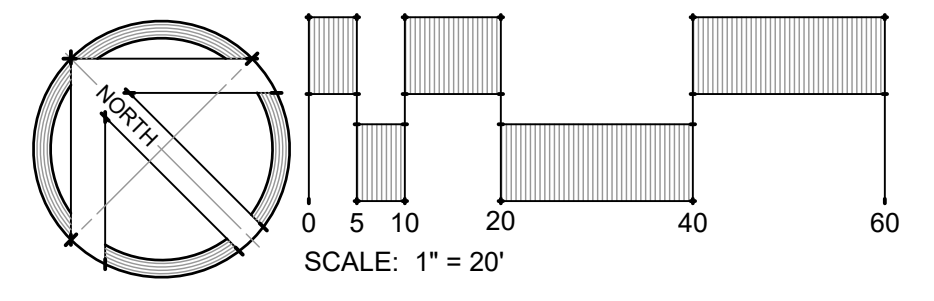

DRAWING NO.:
ESC101

© SITE RESOURCES, INC., Z:\08108038-S1 Marys College ArneeAundeHalDwg\WHIC Pkg_Lo\ESC101 - Existing ESC Plan.dwg-ESC202 Nov_30_2022 04:04pm_zjr

B-4-5 STANDARDS AND SPECIFICATIONS FOR PERMANENT STABILIZATION

DEFINITION

TO STABILIZE DISTURBED SOILS WITH PERMANENT VEGETATION.

PURPOSE

TO USE LONG-LIVED PERENNIAL GRASSES AND LEGUMES TO ESTABLISH PERMANENT GROUND COVER ON DISTURBED SOILS.

CONDITIONS WHERE PRACTICE APPLIES

EXPOSED SOILS WHERE GROUND COVER IS NEEDED FOR 6 MONTHS OR MORE.

CRITERIA

- A. SEED MIXTURES
 1. GENERAL USE
- A. SELECT ONE OR MORE OF THE SPECIES OR MIXTURES LISTED IN TABLE B.3 FOR THE APPROPRIATE PLANT HARDINESS ZONE (FROM FIGURE B.3) AND BASED ON THE SITE CONDITION OR PURPOSE FOUND ON TABLE B.2. ENTER SELECTED MIXTURE(S), APPLICATION RATES, AND SEEDING DATES IN THE PERMANENT SEEDING SUMMARY. THE SUMMARY IS TO BE PLACED ON THE PLAN.
- B. ADDITIONAL PLANTING SPECIFICATIONS FOR EXCEPTIONAL SITES SUCH AS SHORELINES, STREAM BANKS, OR DUNES OR FOR SPECIAL PURPOSES SUCH AS WILDLIFE OR AESTHETIC TREATMENT MAY BE FOUND IN USDA-NRCS TECHNICAL FIELD OFFICE GUIDE, SECTION 344, CRITICAL AREA PLANTING.
- C. FOR SITES HAVING DISTURBED AREA OVER 5 ACRES, USE AND SHOW THE RATES RECOMMENDED BY THE SOIL TESTING AGENCY.
- D. FOR AREAS RECEIVING LOW MAINTENANCE, APPLY UREA FORM FERTILIZER (46-0-0) AT 3 ½ POUNDS PER 1000 SQUARE FEET (150 POUNDS PER ACRE) AT THE TIME OF SEEDING IN ADDITION TO THE SOIL AMENDMENTS SHOWN IN THE PERMANENT SEEDING SUMMARY.
2. TURFGRASS MIXTURES
- A. AREAS WHERE TURFGRASS MAY BE DESIRED INCLUDE LAWNS, PARKS, PLAYGROUNDS, AND COMMERCIAL SITES WHICH WILL RECEIVE A MEDIUM TO HIGH LEVEL OF MAINTENANCE.
- B. SELECT ONE OR MORE OF THE SPECIES OR MIXTURES LISTED BELOW BASED ON THE SITE CONDITIONS OR PURPOSE. ENTER SELECTED MIXTURE(S), APPLICATION RATES, AND SEEDING DATES IN THE PERMANENT SEEDING SUMMARY. THE SUMMARY IS TO BE PLACED ON THE PLAN.
 - i. KENTUCKY BLUEGRASS: FULL SUN MIXTURE: FOR USE IN AREAS THAT RECEIVE INTENSIVE MANAGEMENT. IRRIGATION REQUIRED IN THE AREAS OF CENTRAL MARYLAND AND EASTERN SHORE. RECOMMENDED CERTIFIED KENTUCKY BLUEGRASS CULTIVARS SEEDING RATE: 1.5 TO 2.0 POUNDS PER 1000 SQUARE FEET. CHOOSE A MINIMUM OF THREE KENTUCKY BLUEGRASS CULTIVARS WITH EACH RANGING FROM 10 TO 35 PERCENT OF THE TOTAL MIXTURE BY WEIGHT.
 - ii. KENTUCKY BLUEGRASS/PERENNIAL RYE: FULL SUN MIXTURE: FOR USE IN FULL SUN AREAS WHERE RAPID ESTABLISHMENT IS NECESSARY AND WHEN TURF WILL RECEIVE MEDIUM TO INTENSIVE MANAGEMENT. CERTIFIED PERENNIAL RYEGRASS CULTIVARS/CERTIFIED KENTUCKY BLUEGRASS SEEDING RATE: 2 POUNDS MIXTURE PER 1000 SQUARE FEET. CHOOSE A MINIMUM OF THREE KENTUCKY BLUEGRASS CULTIVARS WITH EACH RANGING FROM 10 TO 35 PERCENT OF THE TOTAL MIXTURE BY WEIGHT.
 - iii. TALL FESCUE/KENTUCKY BLUEGRASS: FULL SUN MIXTURE: FOR USE IN DROUGHT PRONE AREAS AND/OR FOR AREAS RECEIVING LOW TO MEDIUM MANAGEMENT IN FULL SUN TO MEDIUM SHADE. RECOMMENDED MIXTURE INCLUDES: CERTIFIED TALL FESCUE CULTIVARS 95 TO 100 PERCENT, CERTIFIED KENTUCKY BLUEGRASS CULTIVARS 0 TO 5 PERCENT. SEEDING RATE: 5 TO 8 POUNDS PER 1000 SQUARE FEET. ONE OR MORE CULTIVARS MAY BE BLENDED.
 - iv. KENTUCKY BLUEGRASS/FINE FESCUE: SHADE MIXTURE: FOR USE IN AREAS WITH SHADE IN BLUEGRASS LAWNS. FOR ESTABLISHMENT IN HIGH QUALITY, INTENSIVELY MANAGED TURF AREA. MIXTURE INCLUDES: CERTIFIED KENTUCKY BLUEGRASS CULTIVARS 30 TO 40 PERCENT AND CERTIFIED FINE FESCUE AND 60 TO 70 PERCENT. SEEDING RATE: 1½ TO 3 POUNDS PER 1000 SQUARE FEET.
- NOTES:
 - SELECT TURFGRASS VARIETIES FROM THOSE LISTED IN THE MOST CURRENT UNIVERSITY OF MARYLAND PUBLICATION, AGRONOMY MEMO #77, TURFGRASS CULTIVAR RECOMMENDATIONS FOR MARYLAND*
 - CHOOSE CERTIFIED MATERIAL. CERTIFIED MATERIAL IS THE BEST GUARANTEE OF CULTIVAR PURITY. THE CERTIFICATION PROGRAM OF THE MARYLAND DEPARTMENT OF AGRICULTURE, TURF AND SEED SECTION, PROVIDES A RELIABLE MEANS OF CONSUMER PROTECTION AND ASSURES A PURE GENETIC LINE.
- C. IDEAL TIMES OF SEEDING FOR TURF GRASS MIXTURES WESTERN MD: MARCH 15 TO JUNE 1, AUGUST 1 TO OCTOBER 1 (HARDINESS ZONES: 5B, 6A) CENTRAL MD: MARCH 1 TO MAY 15, AUGUST 15 TO OCTOBER 15 (HARDINESS ZONE: 6B) SOUTHERN MD, EASTERN SHORE: MARCH 1 TO MAY 15, AUGUST 15 TO OCTOBER 15 (HARDINESS ZONES: 7A, 7B)
- D. TILL AREAS TO RECEIVE SEED BY DISKING OR OTHER APPROVED METHODS TO A DEPTH OF 2 TO 4 INCHES, LEVEL AND RAKE THE AREAS TO PREPARE A PROPER SEEDBED. REMOVE STONES AND DEBRIS OVER 1 1/2 INCHES IN DIAMETER. THE RESULTING SEEDBED MUST BE IN SUCH CONDITION THAT FUTURE MOWING OF GRASSES WILL POSE NO DIFFICULTY.
- E. IF SOIL MOISTURE IS DEFICIENT, SUPPLY NEW SEEDINGS WITH ADEQUATE WATER FOR PLANT GROWTH (1/2 TO 1 INCH EVERY 3 TO 4 DAYS DEPENDING ON SOIL TEXTURE) UNTIL THEY ARE FIRMLY ESTABLISHED. THIS IS ESPECIALLY TRUE WHEN SEEDINGS ARE MADE LATE IN THE PLANTING SEASON, IN ABNORMALLY DRY OR HOT SEASONS, OR ON ADVERSE SITES.

PERMANENT SEEDING SUMMARY

NO.	SPECIES	APPLICATION RATE (LB/AC)	SEEDING DATES	SEEDING DEPTHS	FERTILIZER RATE (10-20-20)			LIME RATE
					N	P ₂ O ₅	K ₂ O	
***	TALL FESCUE*	285 LB/AC**	3/1 - 5/15 8/15 - 10/15	1/4" - 1/2"	45 LB/AC (1.0 LB/1000SF)	90 LB/AC (2.0 LB/1000SF)	90 LB/AC (2.0 LB/1000SF)	2 TONS/AC
	KENTUCKY BLUEGRASS*	15 LB/AC	3/1 - 5/15 8/15 - 10/15	1/4" - 1/2"				

- * SELECT TURFGRASS VARIETIES FROM THOSE LISTED AS ELIGIBLE "RECOMMENDED VARIETIES" CONTAINED IN THE CURRENT "MARYLAND TURFGRASS VARIETY LIST" PUBLISHED BY THE STATE OF MARYLAND, DEPARTMENT OF AGRICULTURE (MDA), TURF & SEED ADMINISTRATION.
- ** FOR TALL FESCUE CHOOSE 3 PROVEN CULTIVARS TO BE USED IN EQUAL PROPORTIONS IN THE SEED MIX.
- *** SEE 2011 MD STANDARDS & SPECIFICATIONS FOR SOIL, EROSION & SEDIMENT CONTROL, SECTION 4-4.3, PARAGRAPH A.2.B.1 FOR TURFGRASS MIXTURE AND RATE AND PARAGRAPH A.2.C FOR TURFGRASS SEEDING DATES.

- B. SOD: TO PROVIDE QUICK COVER ON DISTURBED AREAS (2:1 GRADE OR FLATTER).
 1. GENERAL SPECIFICATIONS
 - A. CLASS OF TURFGRASS SOD MUST BE MARYLAND STATE CERTIFIED. SOD LABELS MUST BE MADE AVAILABLE TO THE JOB FOREMAN AND INSPECTOR.
 - B. SOD MUST BE MACHINE CUT AT A UNIFORM SOIL THICKNESS OF ¾ INCH, PLUS OR MINUS ¼ INCH, AT THE TIME OF CUTTING. MEASUREMENT FOR THICKNESS MUST EXCLUDE TOP GROWTH AND THATCH. BROKEN PADS AND TORN OR UNEVEN ENDS WILL NOT BE ACCEPTABLE.
 - C. STANDARD SIZE SECTIONS OF SOD MUST BE STRONG ENOUGH TO SUPPORT THEIR OWN WEIGHT AND RETAIN THEIR SIZE AND SHAPE WHEN SUSPENDED VERTICALLY WITH A FIRM GRASP ON THE UPPER 10 PERCENT OF THE SECTION.
 - D. SOD MUST NOT BE HARVESTED OR TRANSPLANTED WHEN MOISTURE CONTENT (EXCESSIVELY DRY OR WET) MAY ADVERSELY AFFECT ITS SURVIVAL.
 - E. SOD MUST BE HARVESTED, DELIVERED, AND INSTALLED WITHIN A PERIOD OF 36 HOURS. SOD NOT TRANSPLANTED WITHIN THIS PERIOD MUST BE APPROVED BY AN AGRONOMIST OR SOIL SCIENTIST PRIOR TO ITS INSTALLATION.
 2. SOD INSTALLATION
 - A. DURING PERIODS OF EXCESSIVELY HIGH TEMPERATURE OR IN AREAS HAVING DRY SUBSOIL, LIGHTLY IRRIGATE THE SUBSOIL IMMEDIATELY PRIOR TO LAYING THE SOD.
 - B. LAY THE FIRST ROW OF SOD IN A STRAIGHT LINE WITH SUBSEQUENT ROWS PLACED PARALLEL TO IT AND TIGHTLY WEDGED AGAINST EACH OTHER. STAGGER LATERAL JOINTS TO PROMOTE MORE UNIFORM GROWTH AND STRENGTH. ENSURE THAT SOD IS NOT STRETCHED OR OVERLAPPED AND THAT ALL JOINTS ARE BUTTED TIGHT IN ORDER TO PREVENT VOIDS WHICH WOULD CAUSE AIR DRYING OF THE ROOTS.
 - C. WHEREVER POSSIBLE, LAY SOD WITH THE LONG EDGES PARALLEL TO THE CONTOUR AND WITH STAGGERING JOINTS. ROLL AND TAMP, PEG OR OTHERWISE SECURE THE SOD TO PREVENT SLIPPAGE ON SLOPES. ENSURE SOLID CONTACT EXISTS BETWEEN SOD ROOTS AND THE UNDERLYING SOIL SURFACE.
 - D. WATER THE SOD IMMEDIATELY FOLLOWING ROLLING AND TAMPING UNTIL THE UNDERSIDE OF THE NEW SOD PAD AND SOIL SURFACE BELOW THE SOD ARE THOROUGHLY WET. COMPLETE THE OPERATIONS OF LAYING, TAMPING AND IRRIGATING FOR ANY PIECE OF SOD WITHIN EIGHT HOURS.
 3. SOD MAINTENANCE
 - A. IN THE ABSENCE OF ADEQUATE RAINFALL, WATER DAILY DURING THE FIRST WEEK OR AS OFTEN AND SUFFICIENTLY AS NECESSARY TO MAINTAIN MOIST SOIL TO A DEPTH OF 4 INCHES. WATER SOD DURING THE HEAT OF THE DAY TO PREVENT WILTING.
 - B. AFTER THE FIRST WEEK, SOD WATERING IS REQUIRED AS NECESSARY TO MAINTAIN ADEQUATE MOISTURE CONTENT.
 - C. DO NOT MOW UNTIL THE SOD IS FIRMLY ROOTED. NO MORE THAN 1/3 OF THE GRASS LEAF MUST BE REMOVED BY THE INITIAL CUTTING OR SUBSEQUENT CUTTINGS. MAINTAIN A GRASS HEIGHT OF AT LEAST 3 INCHES UNLESS OTHERWISE SPECIFIED.

TEMPORARY STOCKPILE NOTE

TEMPORARY STOCKPILES SHALL BE:

1. LOCATED WITHIN THE LIMIT OF DISTURBANCE (LOD).
2. DRAIN TO A FUNCTIONING SEDIMENT CONTROL DEVICE.
3. POSITIONED TO NOT IMPEDE UPON, OR IMPAIR THE FUNCTION OF SAID DEVICES.
4. POSITIONED TO NOT ALTER DRAINAGE DIVIDES.

STANDARD STABILIZATION NOTE

FOLLOWING INITIAL SOIL DISTURBANCE OR REDISTURBANCE, PERMANENT OR TEMPORARY STABILIZATION SHALL BE COMPLETED WITHIN THREE (3) CALENDAR DAYS AS TO THE SURFACE OF ALL PERIMETER CONTROLS, DIKES, SWALES, DITCHES, PERIMETER SLOPES, AND ALL SLOPES STEEPER THAN 3 HORIZONTAL TO 1 VERTICAL (3:1) AND SEVEN (7) DAYS AS TO ALL OTHER DISTURBED OR GRADED AREAS ON THE PROJECT SITE NOT UNDER ACTIVE GRADING.

SAME DAY STABILIZATION NOTE

THE WORK IN THIS AREA SHALL BE DONE USING THE METHOD OF "SAME DAY STABILIZATION". NO MORE AREA SHALL BE DISTURBED THAN CAN BE STABILIZED BY THE END OF THE WORKDAY. ALL DISTURBED AREAS THAT DO NOT DRAIN TO A SEDIMENT CONTROL DEVICE SHALL BE STABILIZED AT THE END OF THE WORKDAY. NO DISTURBED AREA SHALL BE LEFT UNSTABILIZED OVERNIGHT UNLESS THE RUNOFF IS DIRECTED TO AN MDE APPROVED SEDIMENT CONTROL DEVICE.

STABILIZATION SHALL BE AS FOLLOWS :

- FOR AREAS TO BE PAVED : APPLICATION OF STONE SUBBASE.
- FOR AREAS TO BE VEGETATIVELY STABILIZED : PERMANENT SEED AND EROSION CONTROL MATTING FOR ALL SWALES/CHANNELS AND PERMANENT SEED AND MULCH FOR ALL OTHER AREAS.

MAINTENANCE OF SEDIMENT CONTROL

CONTRACTOR SHALL, WITHOUT EXTRA COST TO THE PROJECT, REPAIR AND MAINTAIN EXISTING SEDIMENT CONTROL DEVICES UNTIL ALL AREAS WITHIN LIMITS OF CONSTRUCTION ARE STABILIZED. ALL SEDIMENT CONTROL MEASURES REFERRED TO ON THESE PLANS SHALL BE IN ACCORDANCE WITH THE PUBLICATION ENTITLED 1994 MARYLAND STANDARDS AND SPECIFICATIONS FOR EROSION AND SEDIMENT CONTROL. EROSION AND SEDIMENT CONTROL WILL BE STRICTLY ENFORCED.

STANDARD ENFORCEMENT NOTE

NOTE TO CONTRACTOR: EROSION/SEDIMENT CONTROL WILL BE STRICTLY ENFORCED

SEQUENCE OF CONSTRUCTION

1. CONTACT REPRESENTATIVES OF UTILITY OWNERS AND MISS UTILITY AT 1-800-257-7777 AT LEAST THREE DAYS IN ADVANCE OF STARTING WORK SHOWN ON THE PLANS.
2. BEFORE PERFORMING ANY WORK, CONTRACTOR SHALL INSTALL TEMPORARY CONSTRUCTION FENCING AROUND ALL ACTIVE WORK AREAS TO RESTRICT ACCESS TO CONSTRUCTION OPERATIONS. ANY WALKS, ROADS, CURBS, ETC. OR ANY UTILITY OR STRUCTURE DAMAGED DURING CONSTRUCTION, NOT SCHEDULED FOR DEMOLITION, SHALL BE REPLACED IN KIND BY THE CONTRACTOR.
3. CONTRACTOR SHALL REDIRECT AND MAINTAIN PEDESTRIAN PATH ACCESS FROM THE MIDDLE STREET PATH DURING CONSTRUCTION.
4. CLEAR AND GRUB MINIMUM AREA REQUIRED FOR INSTALLATION OF THE PERIMETER SEDIMENT AND EROSION CONTROL MEASURES. INSTALL FILTER LOG AND TREE PROTECTION FENCING.
5. CLEAR AND GRUB REMAINDER OF SITE.
6. BEGIN GRADING THE SITE AND REMOVAL OF EXISTING PERMEABLE PAVERS AND SUB-BASE AS DIRECTED ON THE PLANS. ALL SLOPES STEEPER THAN 5:1 SHALL BE STABILIZED WITH PERMANENT SEED AND SOIL STABILIZATION MATTING. CONTRACTOR SHALL INSPECT AND MAINTAIN ALL EROSION & SEDIMENT CONTROL MEASURES AND DEVICES AFTER EACH STORM EVENT. MAINTENANCE SHALL INCLUDE, BUT NOT LIMITED TO, REMOVAL OF ALL ACCUMULATED SEDIMENT.
7. BEGIN CONSTRUCTION OF PROPOSED IMPROVEMENTS AS SHOWN ON THE PLANS.
8. AFTER PERMANENT STABILIZATION OF THE SITE WITH ESTABLISHED VEGETATION AND/OR PAVEMENT AND REMOVE EROSION AND SEDIMENT CONTROL MEASURES OR DEVICES AND STABILIZE THOSE AREAS DISTURBED BY THIS PROCESS.

REVISIONS





#	DATE	DESCRIPTION

DRAWN BY: ZJR CHECKED BY: PCS
 DATE: 12/09/2022 PROJECT #: 08038
 SCALE: AS SHOWN

DRAWING NAME:
EROSION & SEDIMENT CONTROL NOTES

DRAWING NO.:

ESC202

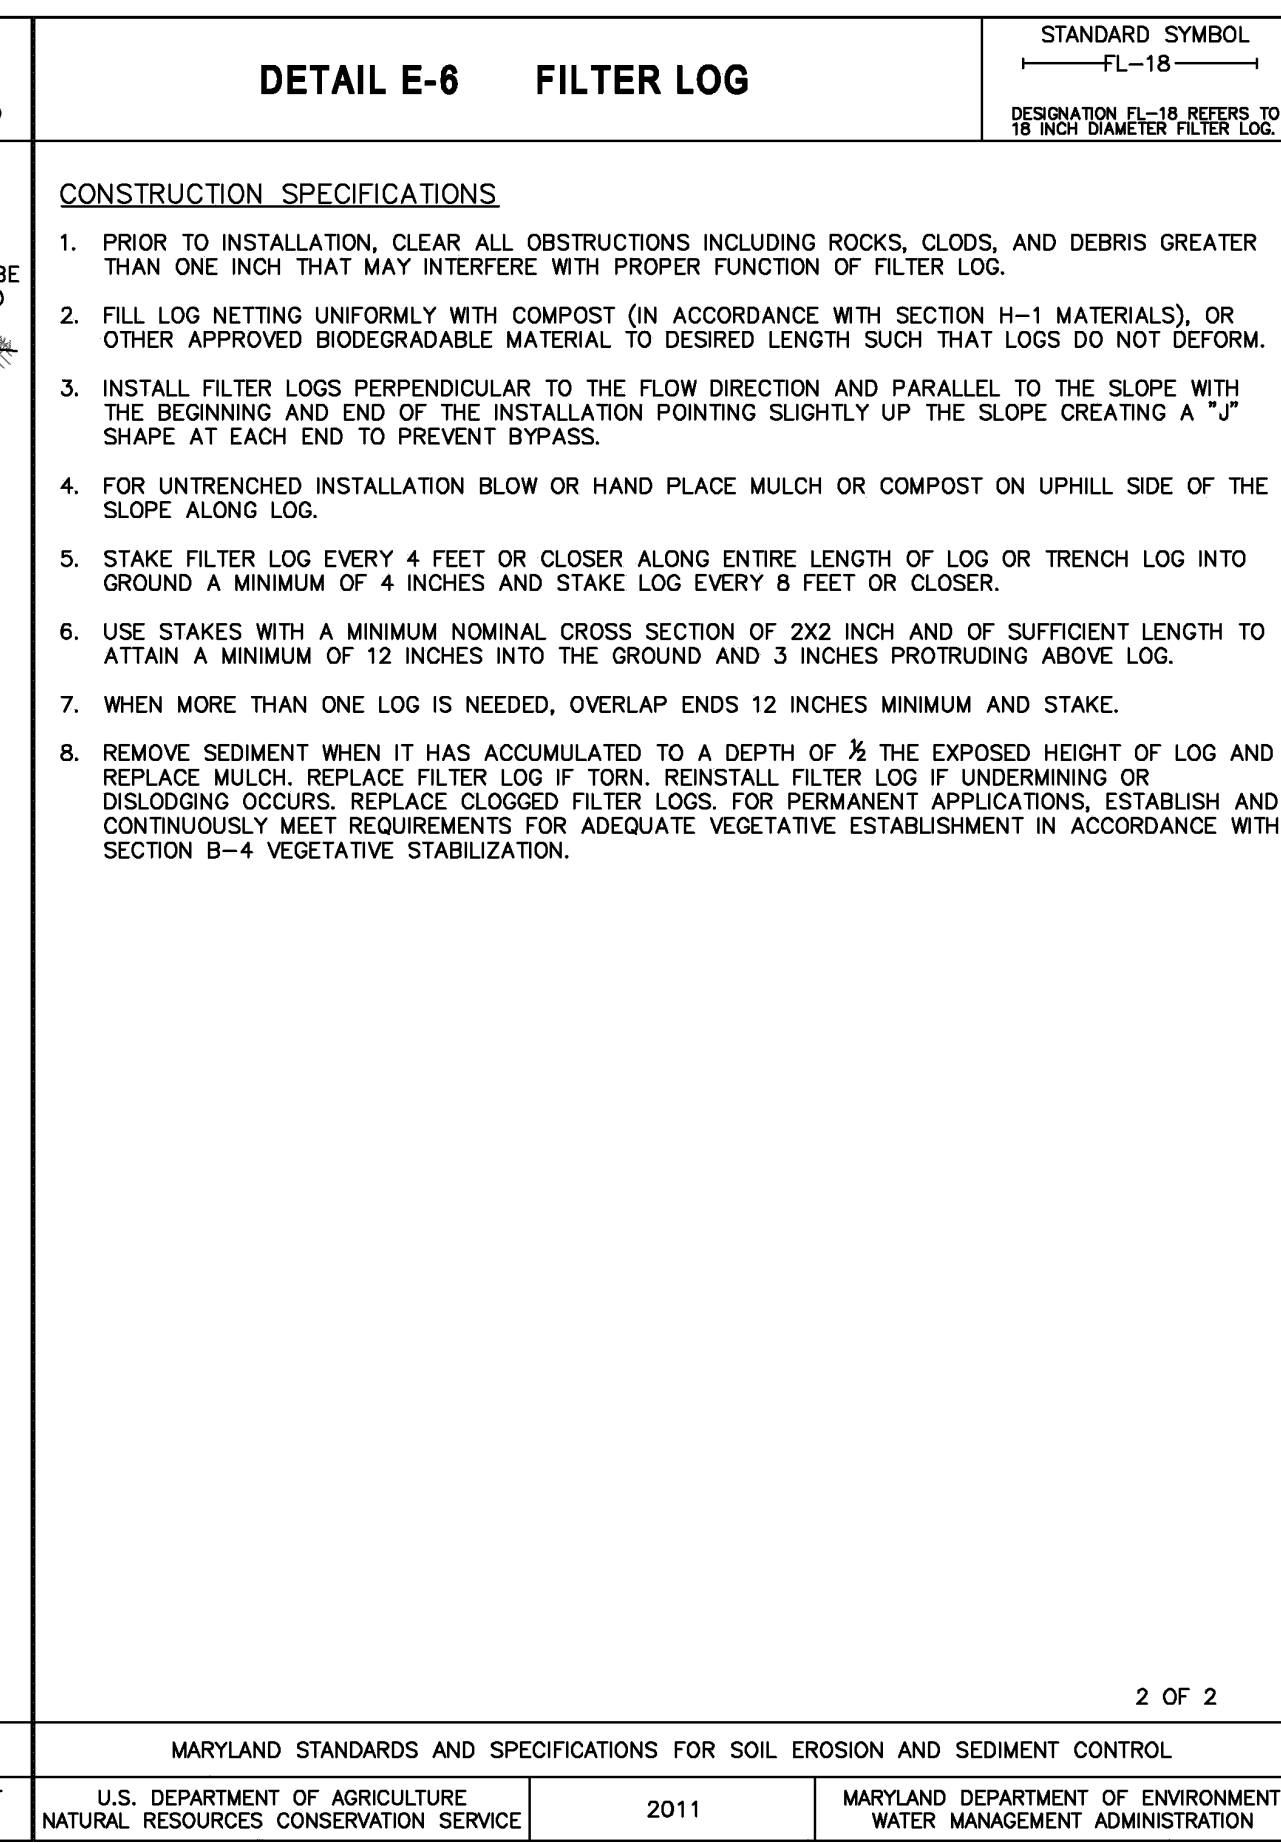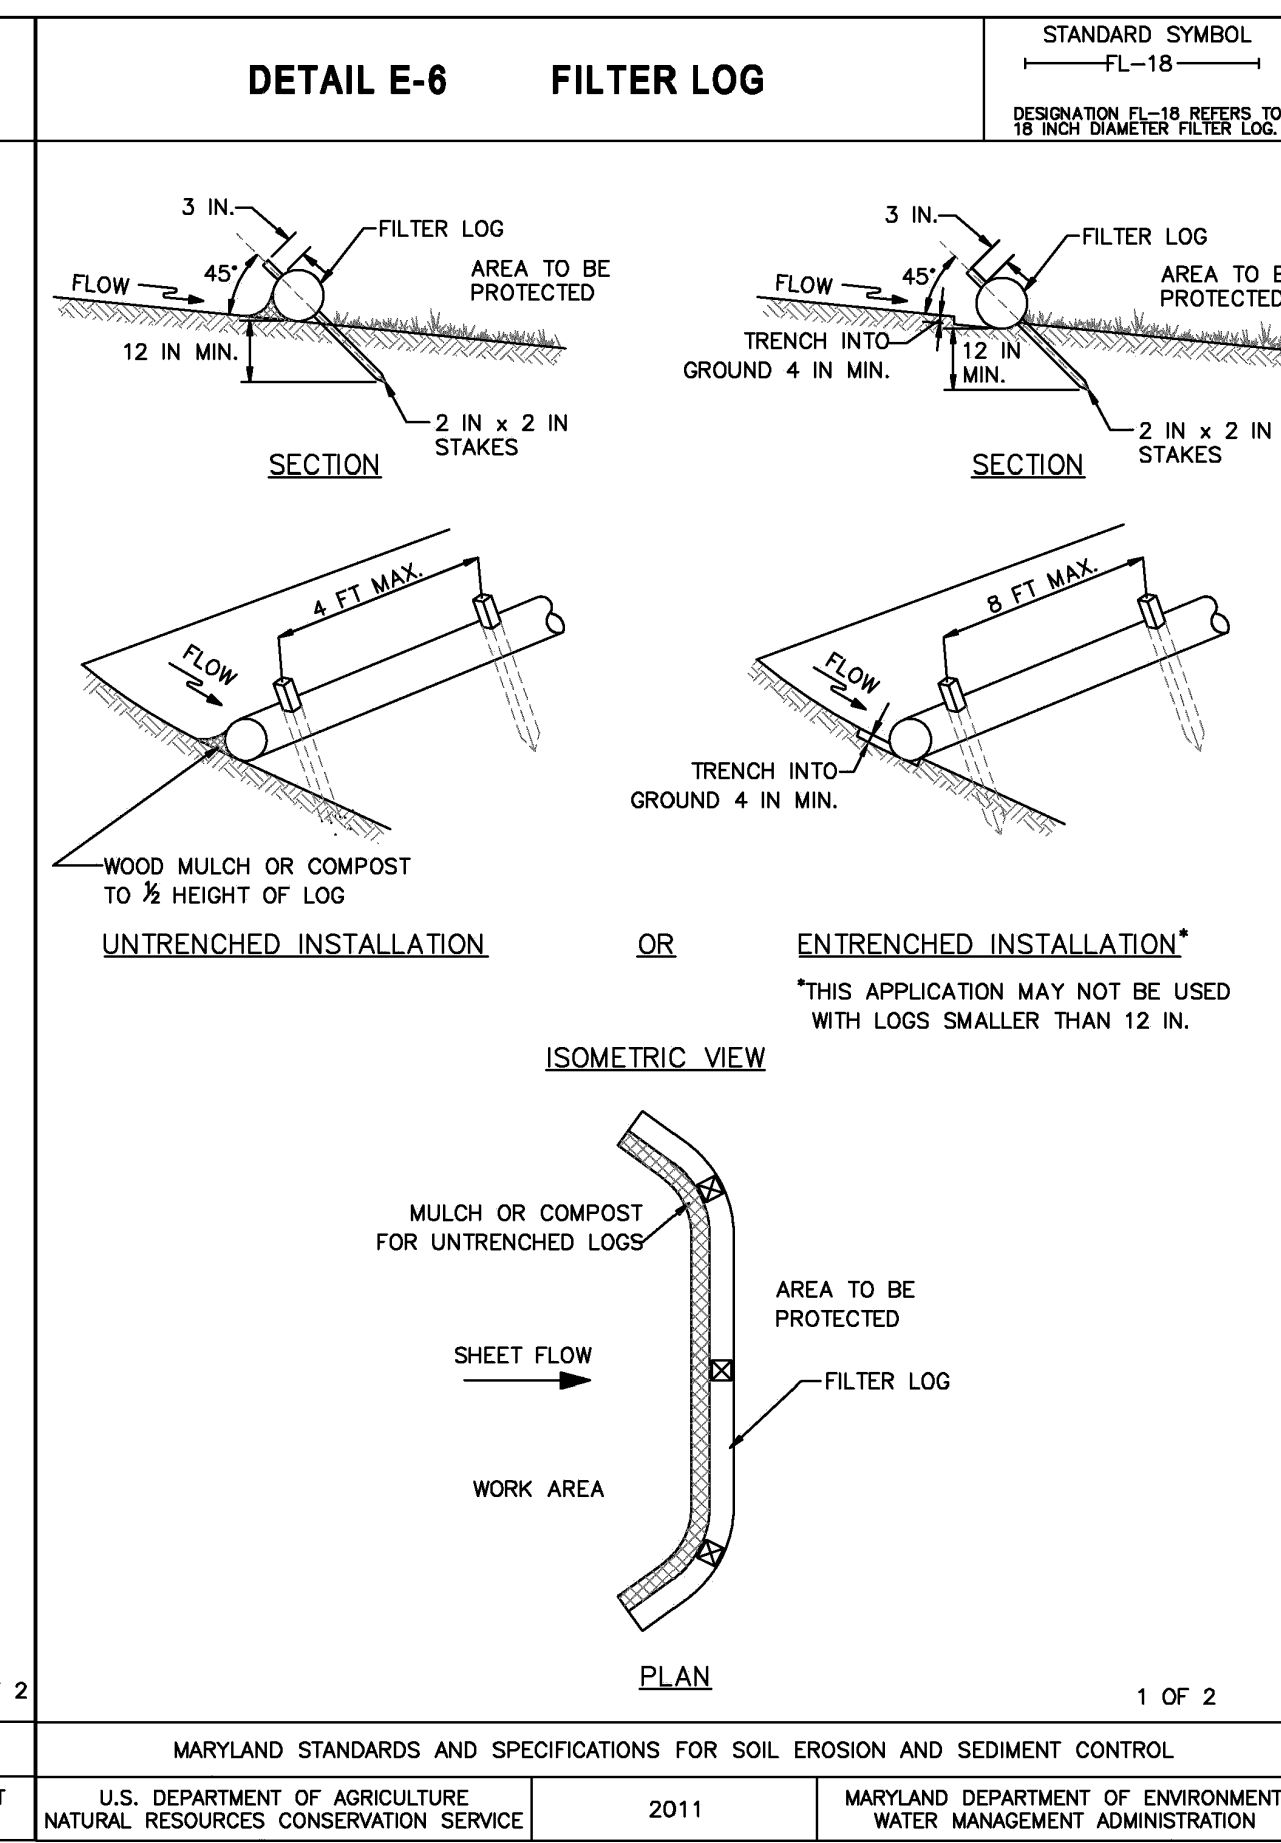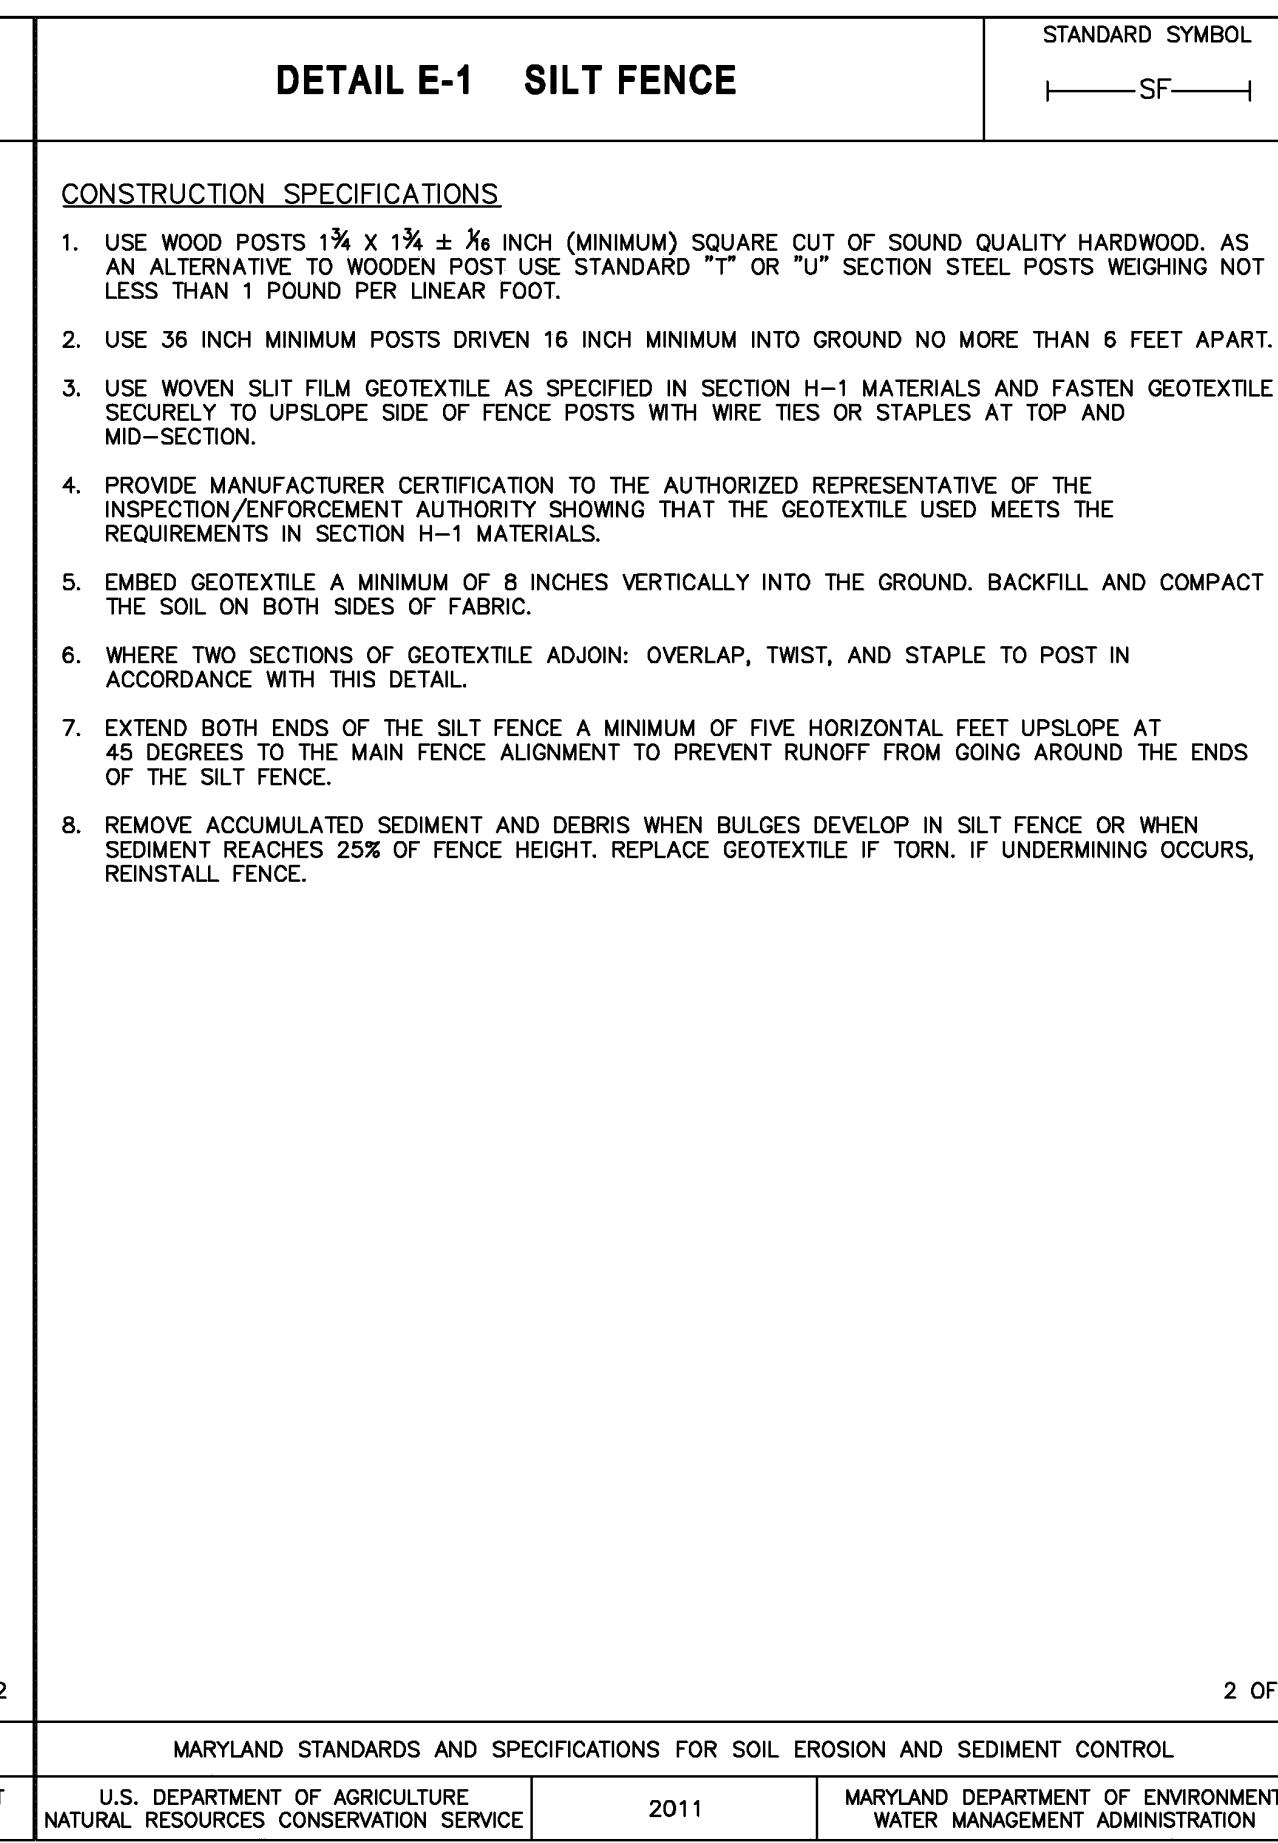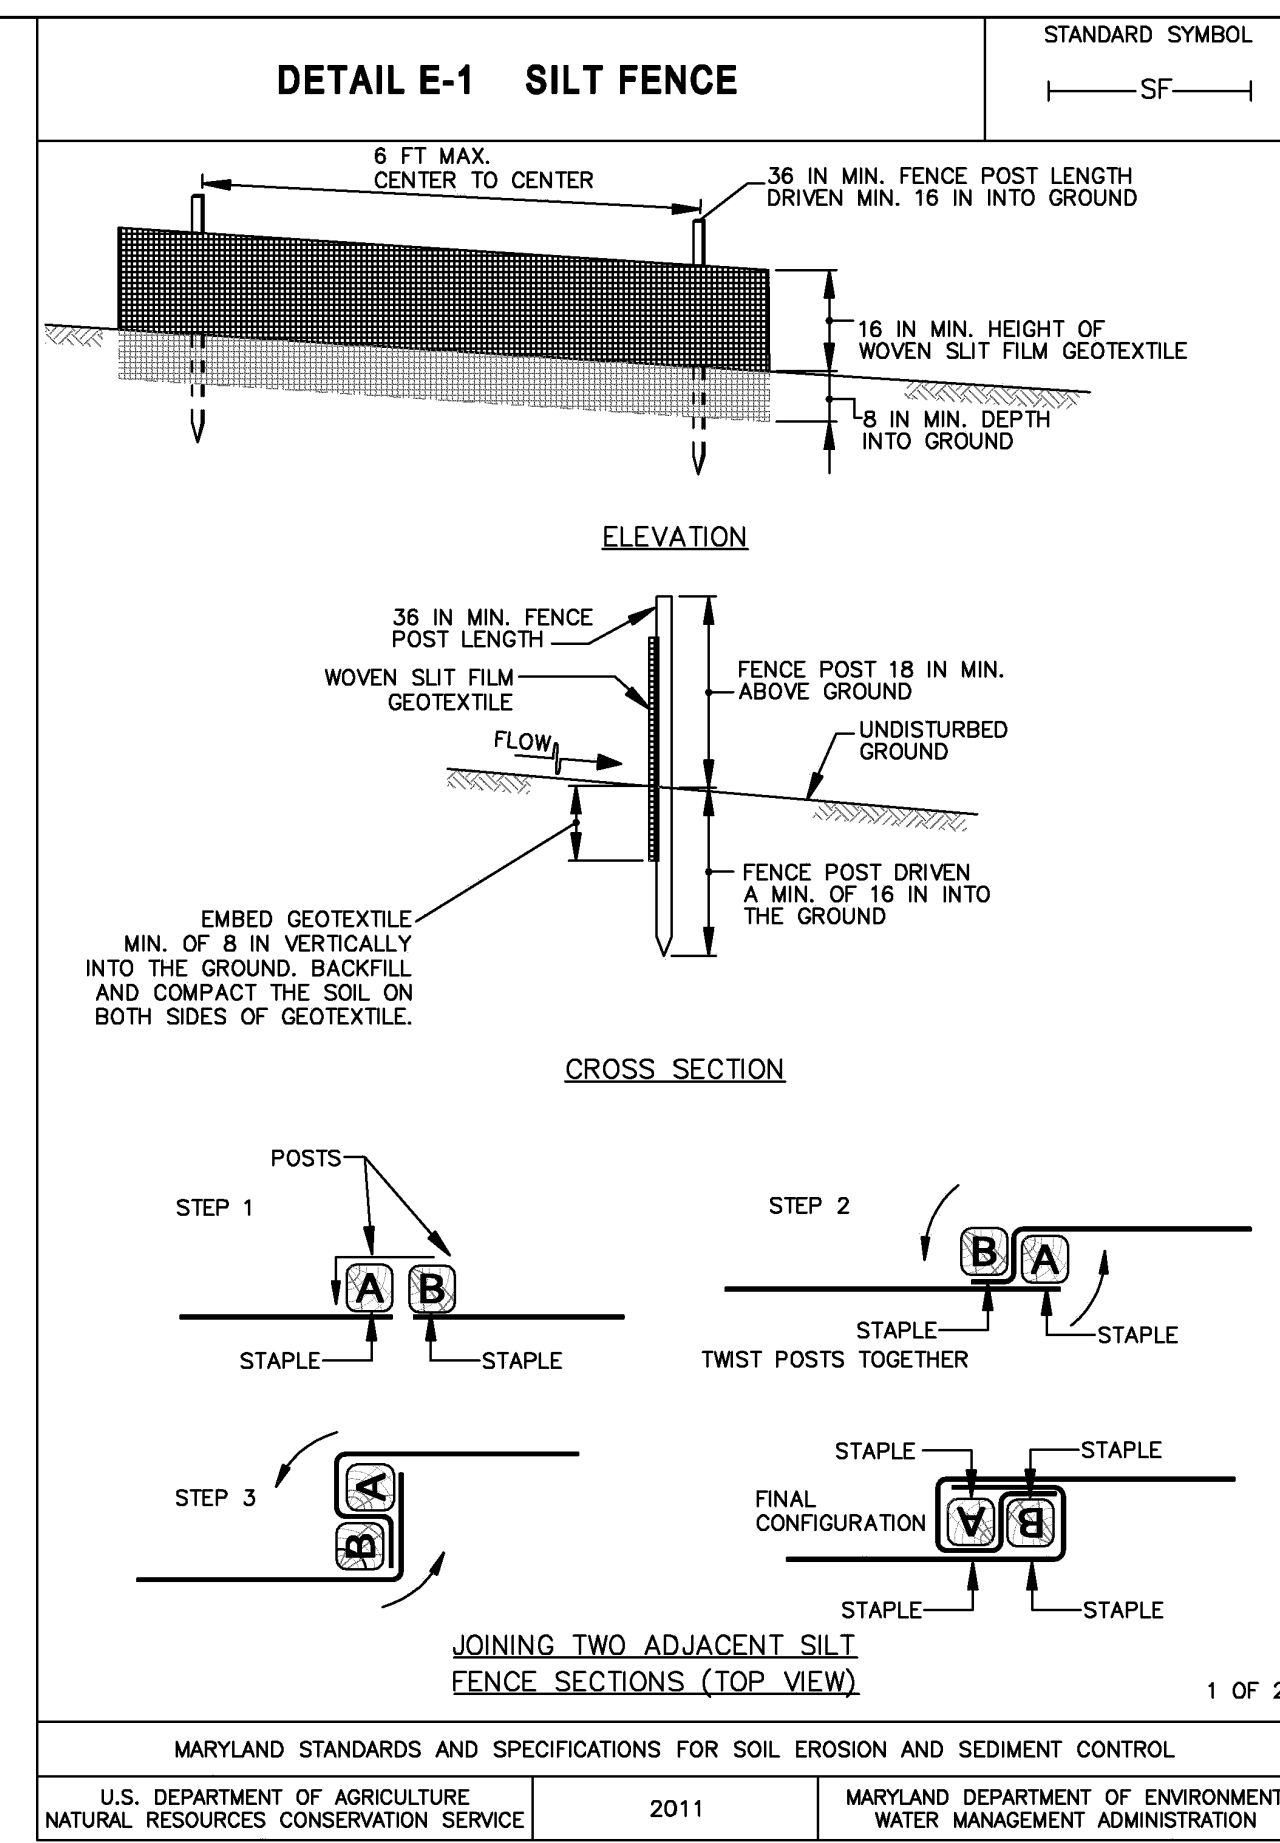


MARYLAND STANDARDS AND SPECIFICATIONS FOR SOIL EROSION AND SEDIMENT CONTROL
U.S. DEPARTMENT OF AGRICULTURE NATURAL RESOURCES CONSERVATION SERVICE 2011

MARYLAND STANDARDS AND SPECIFICATIONS FOR SOIL EROSION AND SEDIMENT CONTROL
U.S. DEPARTMENT OF AGRICULTURE NATURAL RESOURCES CONSERVATION SERVICE 2011

MARYLAND STANDARDS AND SPECIFICATIONS FOR SOIL EROSION AND SEDIMENT CONTROL
U.S. DEPARTMENT OF AGRICULTURE NATURAL RESOURCES CONSERVATION SERVICE 2011

MARYLAND STANDARDS AND SPECIFICATIONS FOR SOIL EROSION AND SEDIMENT CONTROL
U.S. DEPARTMENT OF AGRICULTURE NATURAL RESOURCES CONSERVATION SERVICE 2011

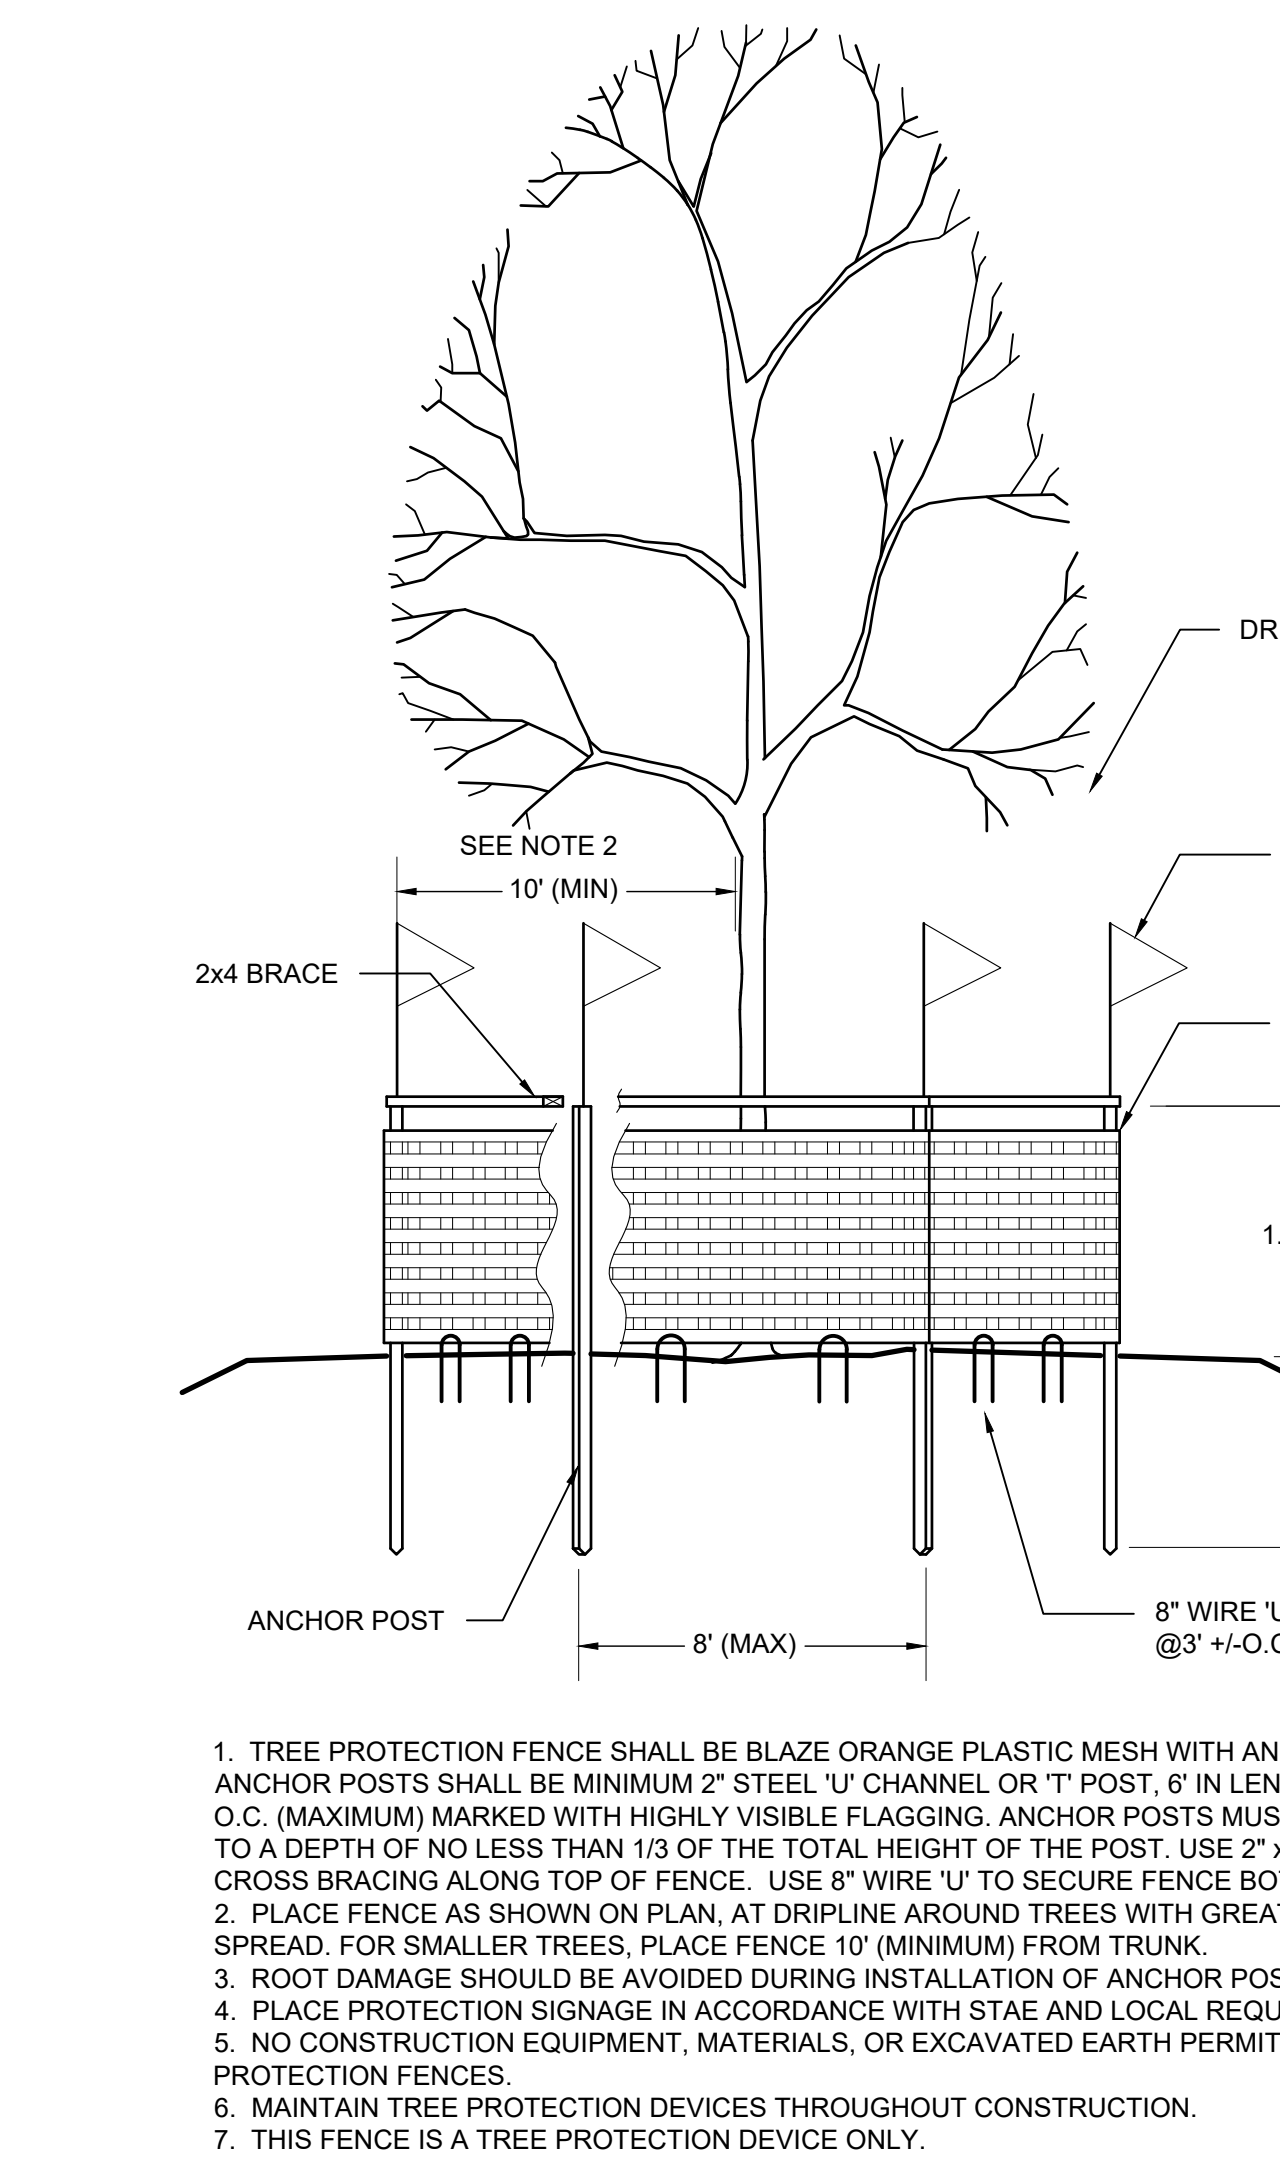

HISTORIC ST. MARY'S CITY & ST. MARY'S COLLEGE OF MARYLAND

MARYLAND HERITAGE INTERPRETIVE CENTER PARKING LOT

ST. MARY'S CITY, MD




PROFESSIONAL CERTIFICATION
I HEREBY CERTIFY THAT THESE DOCUMENTS WERE PREPARED OR APPROVED BY ME, AND THAT I AM A DULY LICENSED PROFESSIONAL ENGINEER UNDER THE LAWS OF THE STATE OF MARYLAND. LICENSE NO. 42977. EXPIRATION DATE: 06/07/2023.

REVISIONS

#	DATE	DESCRIPTION

DRAWN BY: ZJR CHECKED BY: PCS
DATE: 12/09/2022 PROJECT #: 08038
SCALE: AS SHOWN
DRAWING NAME:
EROSION & SEDIMENT CONTROL DETAILS

DRAWING NO.:
ESC203

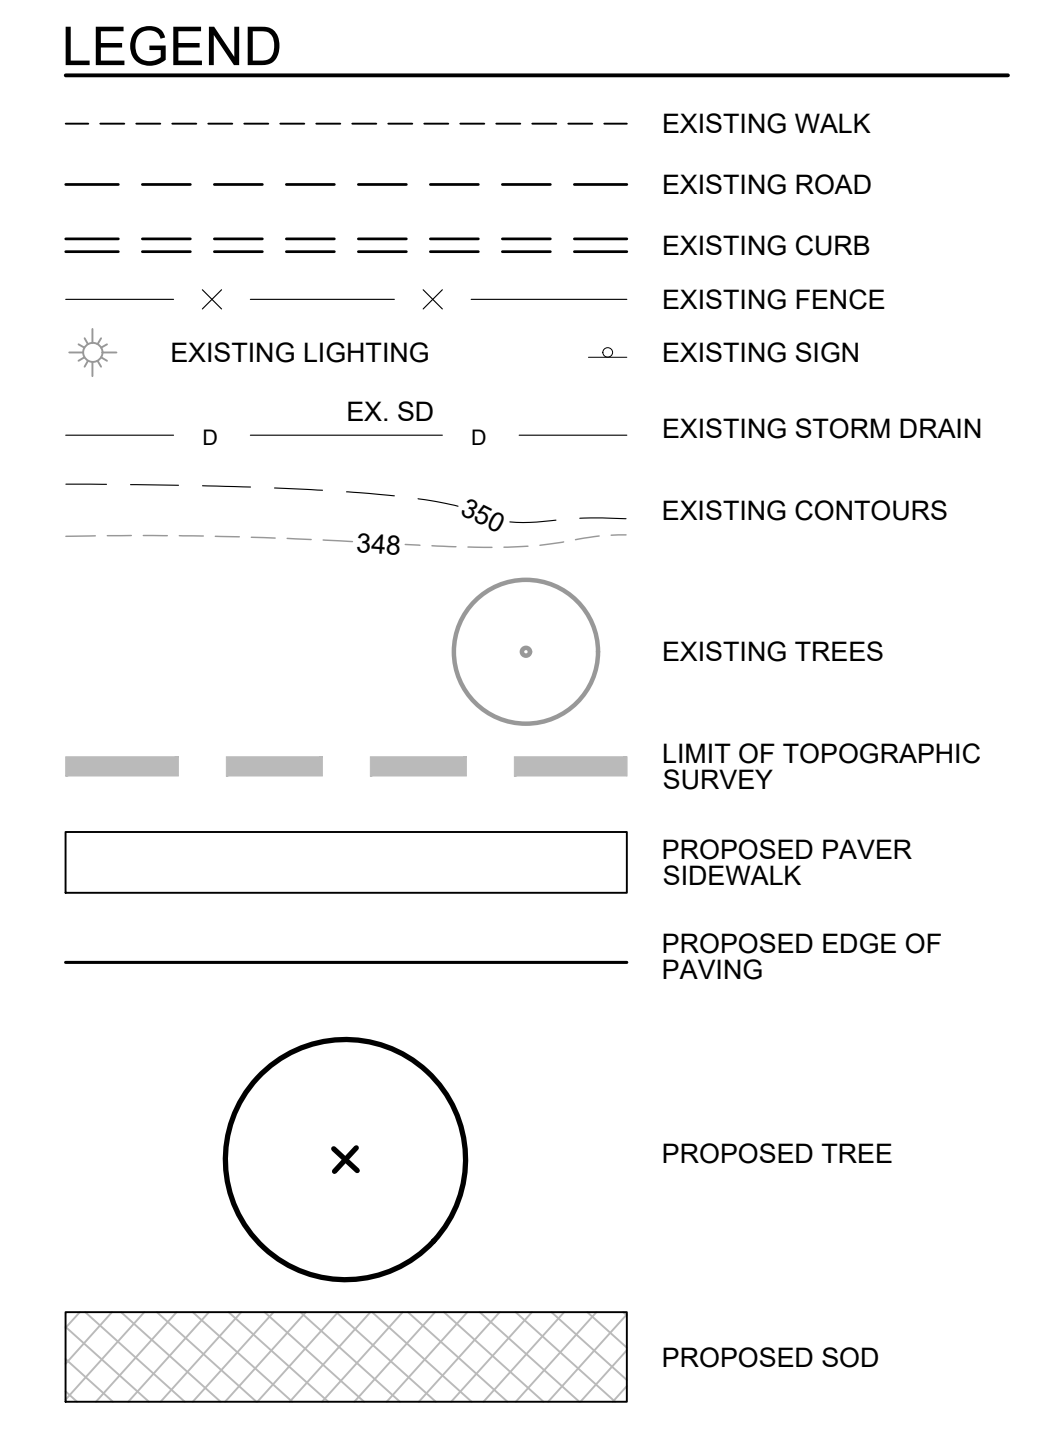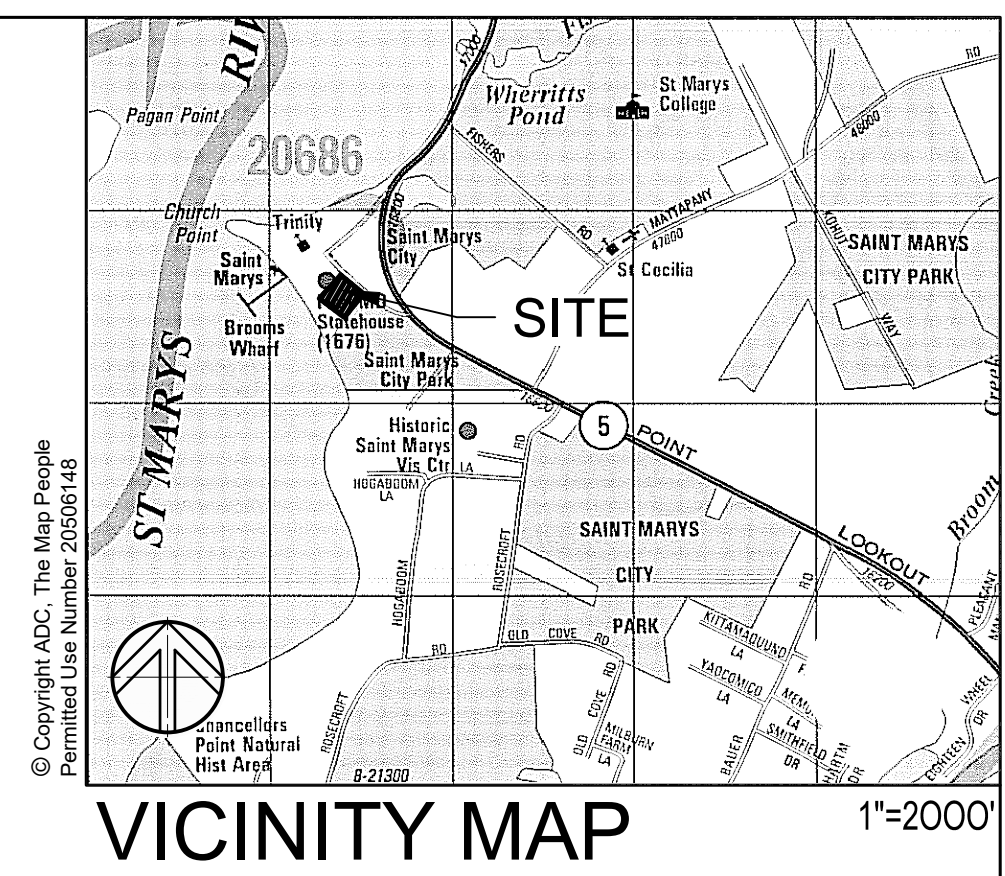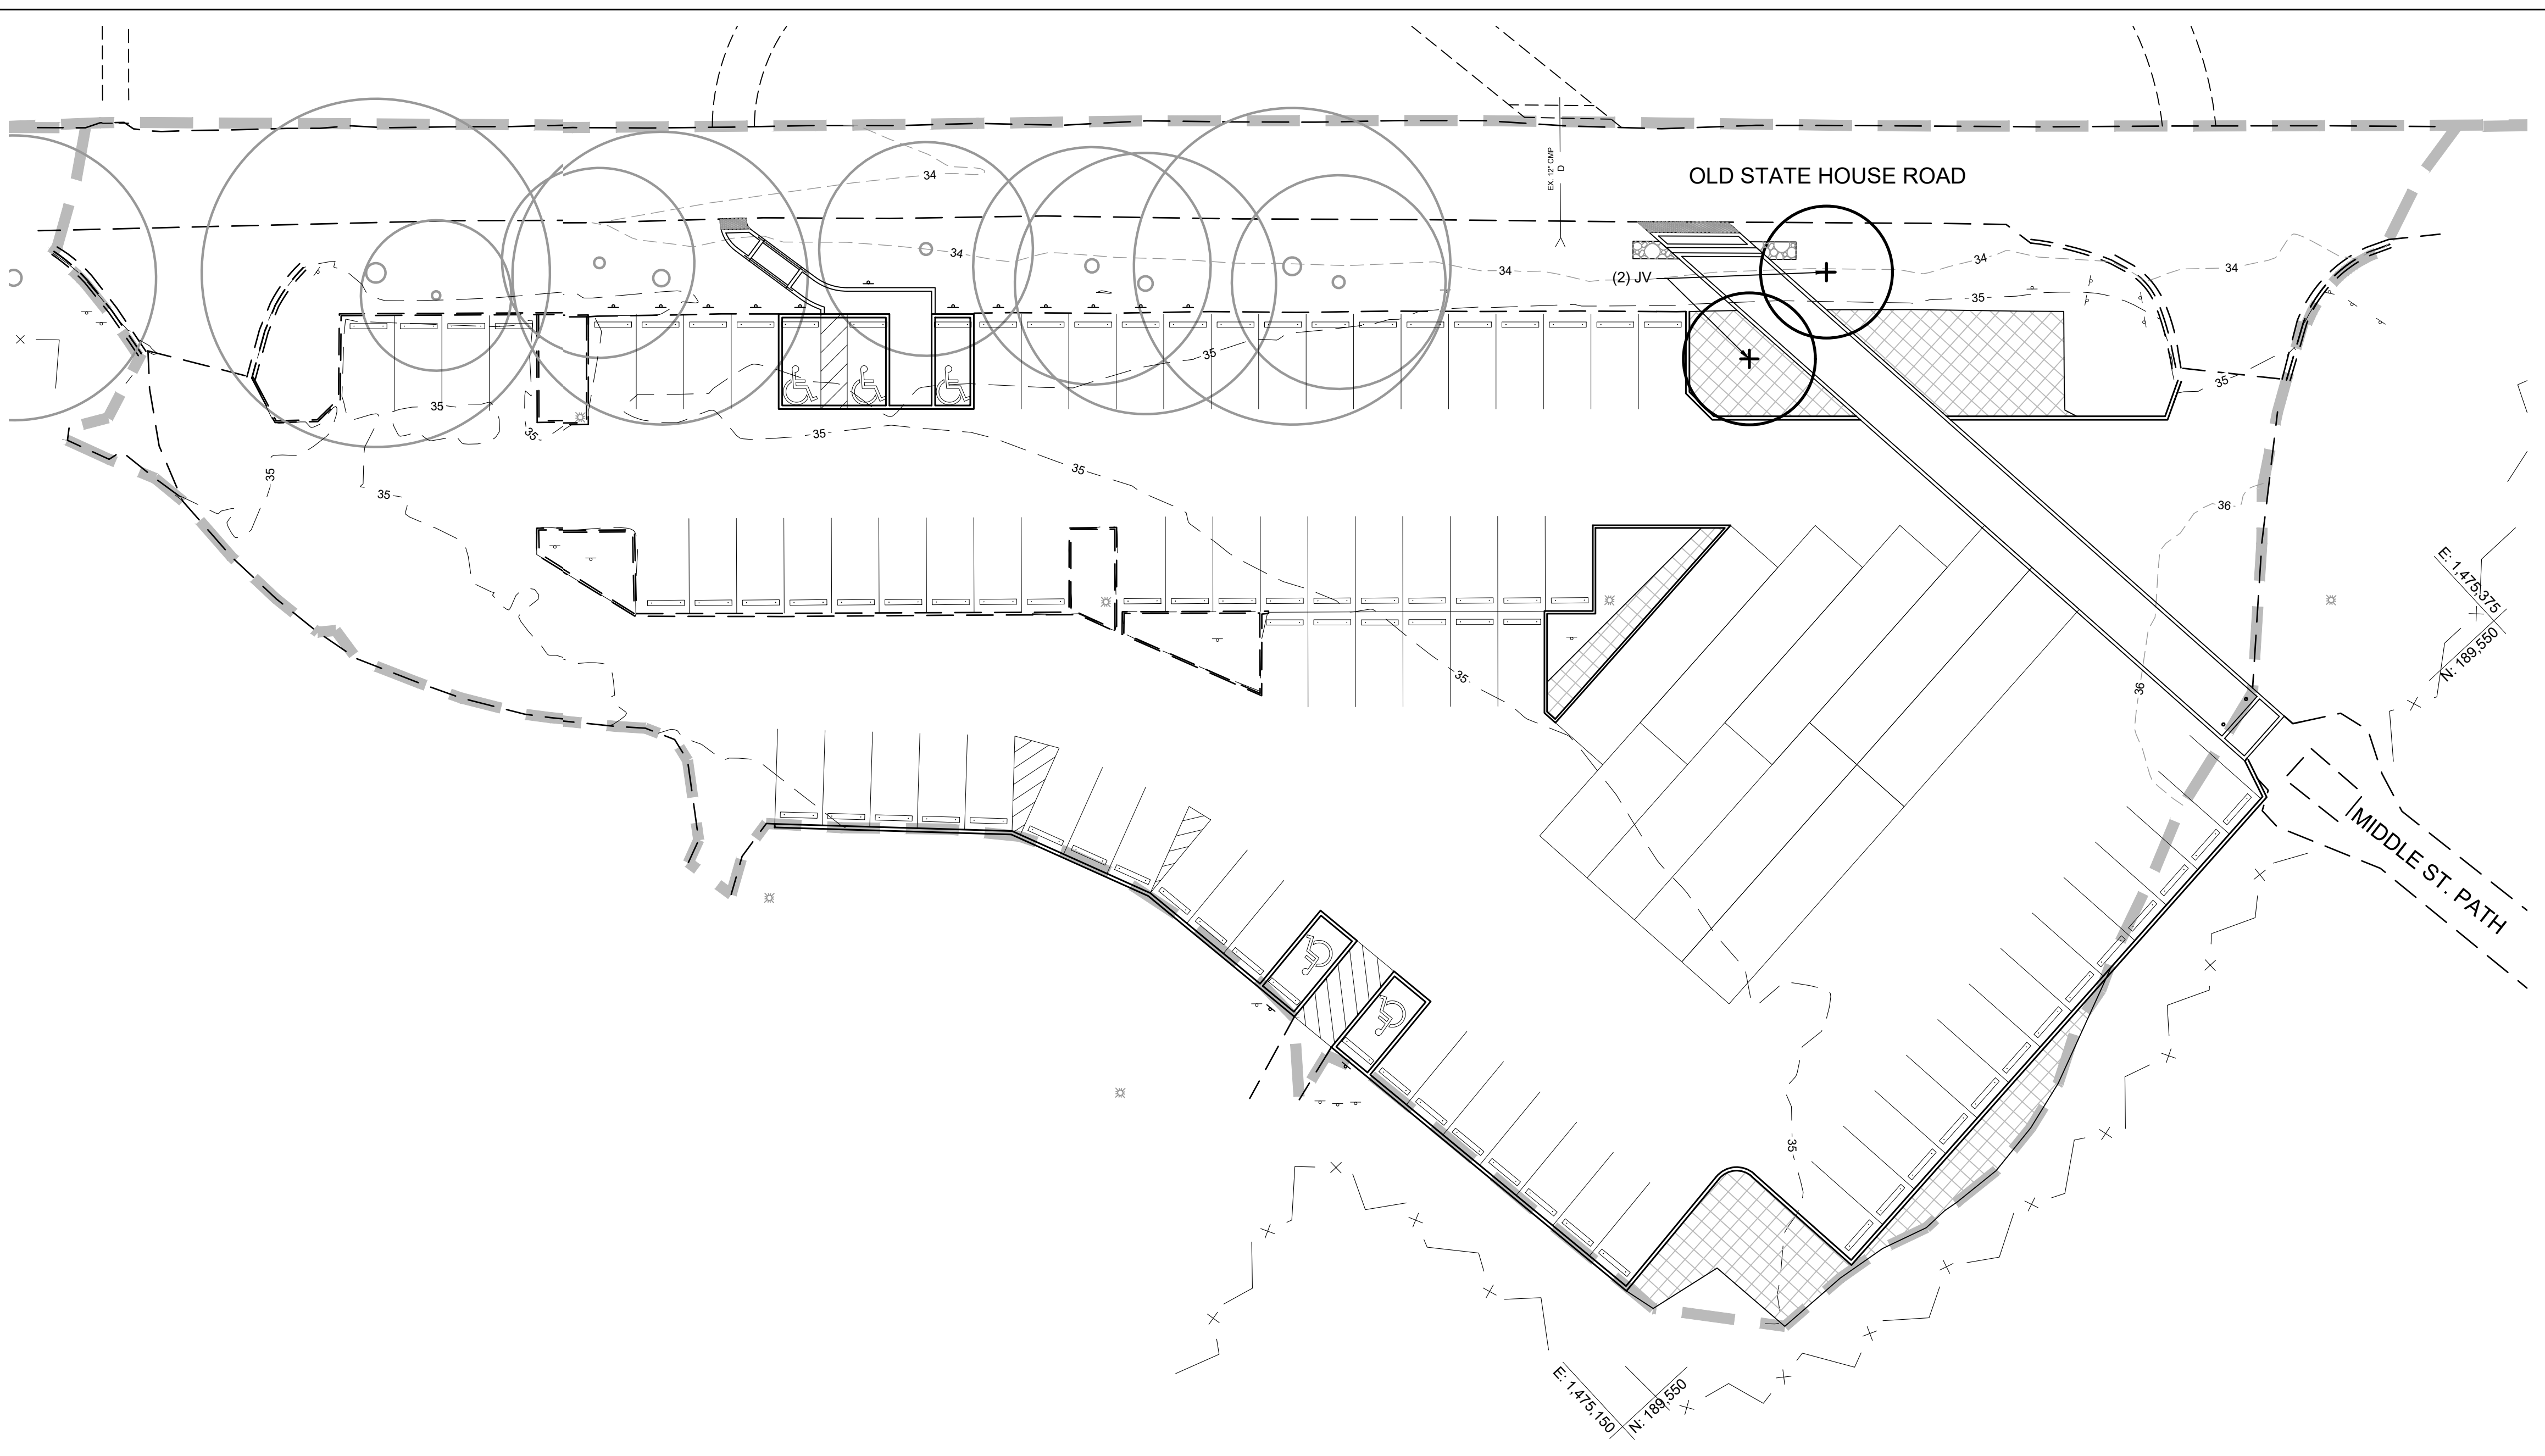


HISTORIC ST. MARY'S CITY & ST. MARY'S COLLEGE OF MARYLAND

MARYLAND HERITAGE INTERPRETIVE CENTER PARKING LOT

ST. MARY'S CITY, MD

PROFESSIONAL CERTIFICATION
I HEREBY CERTIFY THAT THESE DOCUMENTS WERE PREPARED OR APPROVED BY ME, AND THAT I AM A FULLY LICENSED PROFESSIONAL ENGINEER UNDER THE LAWS OF THE STATE OF MARYLAND. LICENSE NO. 42977.
EXPIRATION DATE: 06/07/2023.

© SITE RESOURCES, INC. Z:\08108038-St. Marys College-ArmedeHalDwg\WHIC Pkg_LotL101 Landscape Plan.dwg-L101 Nov 30, 2022 04:04pm zjr

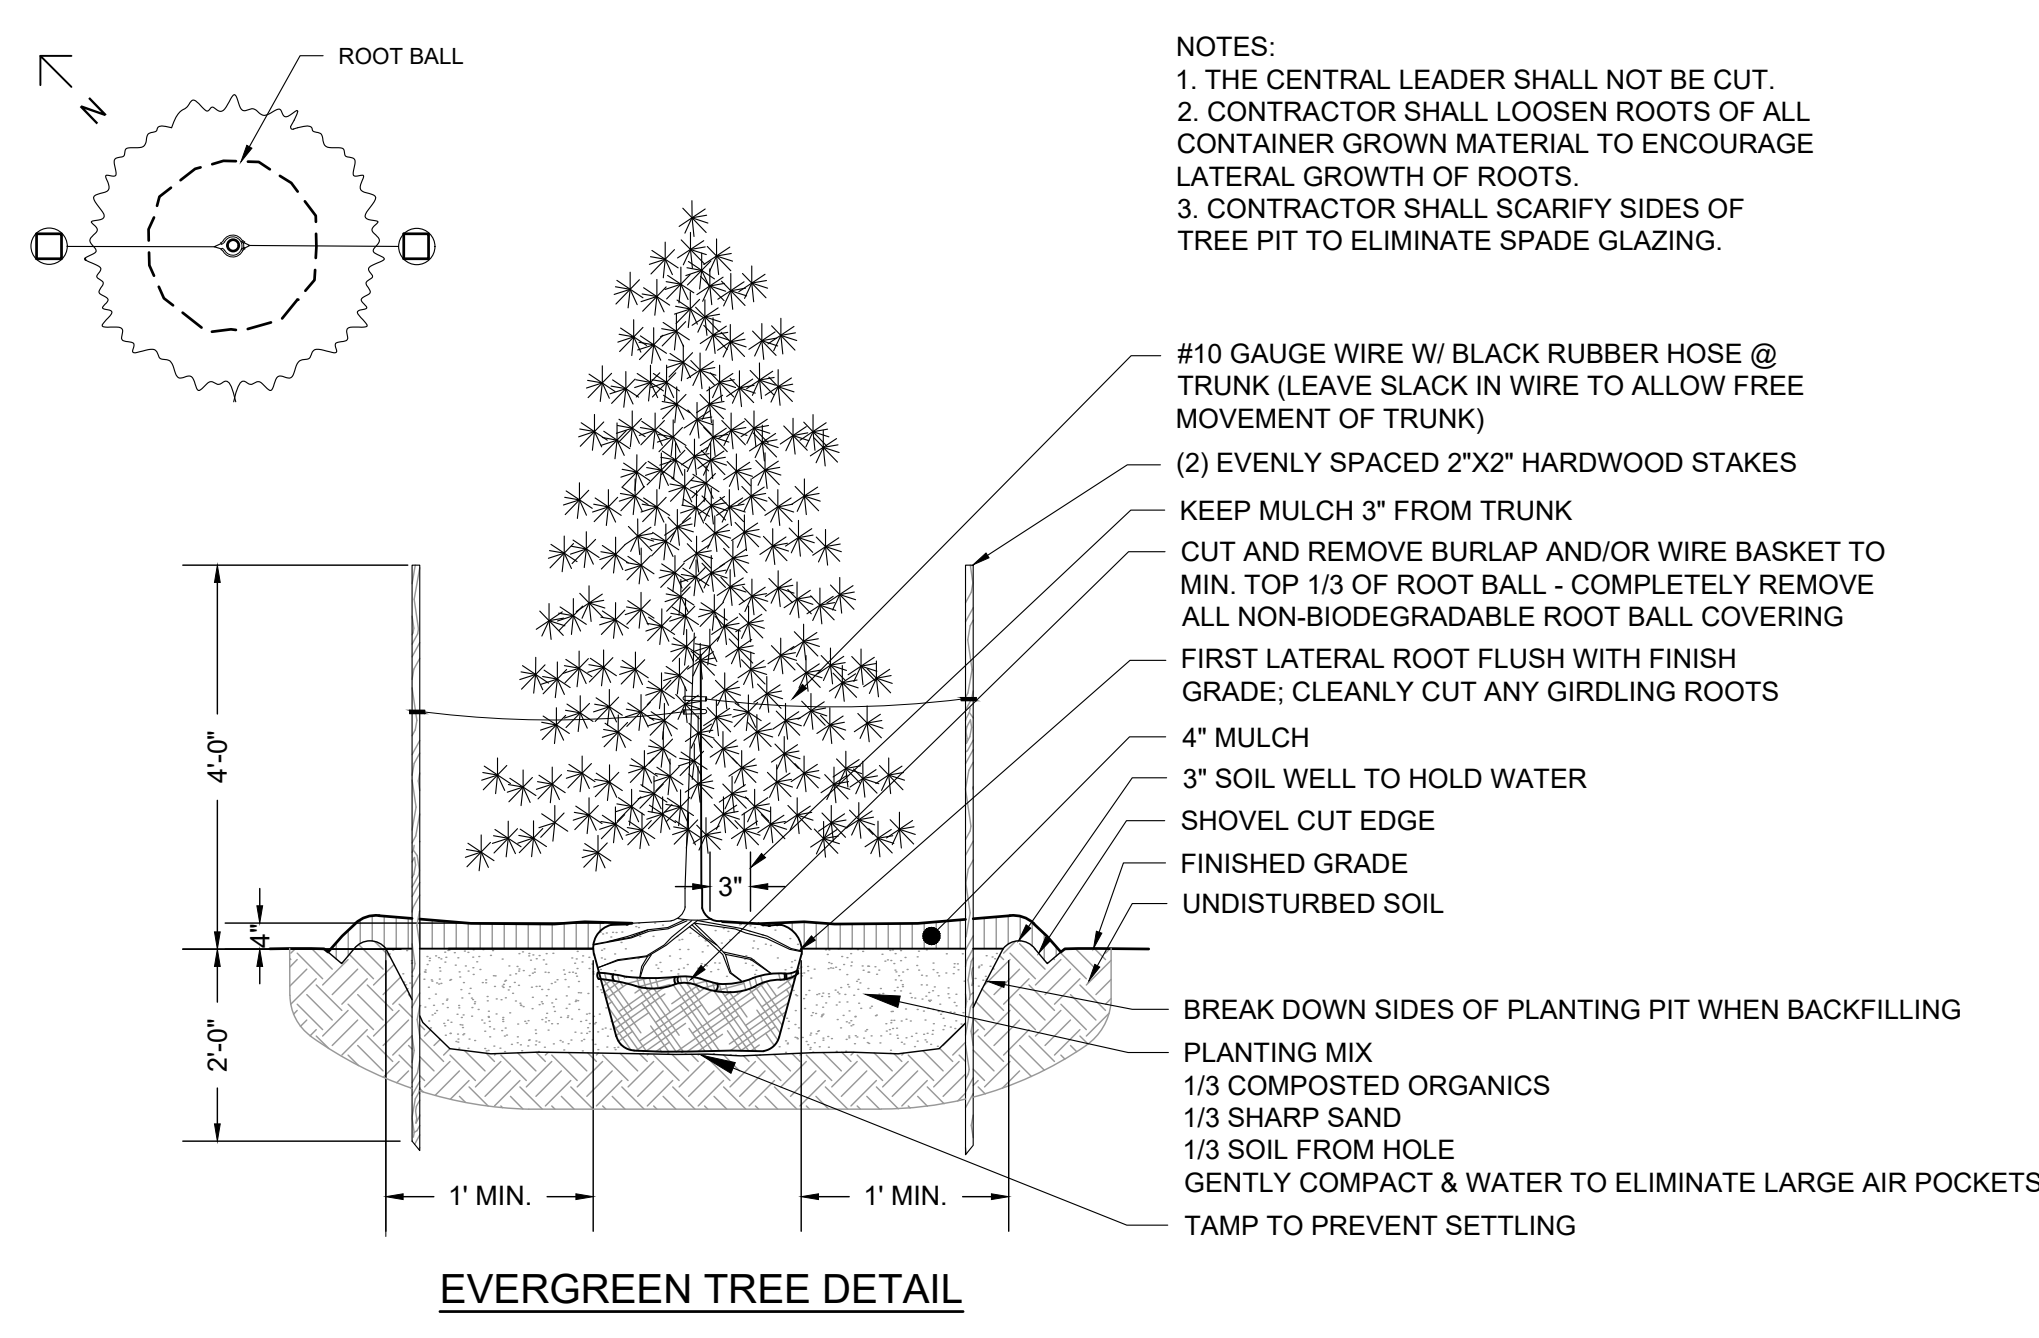

PLANT SCHEDULE						
KEY	QTY	BOTANICAL NAME	COMMON NAME	SIZE	SPACING	REMARKS
EVERGREEN TREES						
JV	2	JUNIPERUS VIRGINIANA	EASTERN RED CEDAR	12-14' HT.	AS SHOWN	STRONG SINGLE LEADER/SPECIMEN


GENERAL LANDSCAPE NOTES
(THESE NOTES APPLY TO ALL PLANTING IN THIS CONTRACT)

- IT IS THE RESPONSIBILITY OF THE CONTRACTOR TO VERIFY THE ACCURACY OF EXISTING AND UTILITY INFORMATION PROVIDED ON THE PLANS, AS WELL AS EXISTING SITE CONDITIONS PRIOR TO PLANTING. IF DISCREPANCIES ARE FOUND, THE CONTRACTOR SHALL IMMEDIATELY REPORT THE INCONSISTENCIES TO THE LANDSCAPE ARCHITECT.
- THE CONTRACTOR SHALL CONTACT THE LOCAL UTILITY LOCATING SERVICE AS REQUIRED BY LAW PRIOR TO BEGINNING ANY PLANTING OPERATIONS.
- QUANTITIES SHOWN ON THE PLANT SCHEDULE ARE FOR THE CONVENIENCE OF THE CONTRACTOR ONLY. PLANT SYMBOLS SHOWN ON THE PLANS TAKE PRECEDENCE OVER THE QUANTITIES NOTED. AS SUCH, THE CONTRACTOR SHALL BE RESPONSIBLE FOR ALL PLANTINGS AS SHOWN.
- PLANT MATERIAL SUBSTITUTIONS WILL NOT BE ACCEPTABLE WITHOUT ADVANCE WRITTEN AUTHORIZATION FROM THE OWNER AND/OR LANDSCAPE ARCHITECT. MATERIAL PLANTED WITHOUT PRIOR APPROVAL WILL BE SUBJECT TO REJECTION.
- REFER TO SPECIFICATION SECTION 329300 "PLANTS" FOR ADDITIONAL PLANTING REQUIREMENTS.

REVISIONS

#	DATE	DESCRIPTION

DRAWN BY: ZJR CHECKED BY: PCS
DATE: 12/09/2022 PROJECT #: 08038
SCALE: AS SHOWN
DRAWING NAME:
LANDSCAPE PLAN

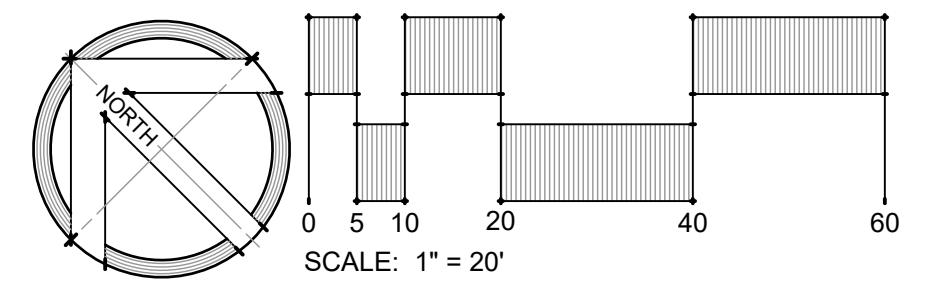

DRAWING NO.: **L101**